

ABBREVIATIONS

Table of abbreviations organized in columns and rows, listing terms like AACB, A/C, AB, ACB, etc., and their corresponding full names.

GENERAL NOTES

- 1. ALL CONTRACTORS SHALL VISIT THE SITE AND VERIFY ALL EXISTING CONDITIONS BEFORE SUBMITTING A BID...
2. CONTRACTOR SHALL PROVIDE ALL REQUIRED SAFETY PROTECTION DURING CONSTRUCTION...
3. IT SHALL BE THE CONTRACTOR'S RESPONSIBILITY TO PROVIDE A SUFFICIENT WORK FORCE TO MEET COMPLETION DATES AS OUTLINED IN THE SPECIFICATIONS...

DRAWING INDEX


Table listing drawing categories and sheet numbers: GENERAL (G001, G002), ARCHITECTURAL (A101-A701), MECHANICAL (H001-H601), ELECTRICAL (E001-E701), PLUMBING (P001-P501).

16. CONSTRUCTION AREA IS LIMITED TO WORK AREA SHOWN ON SHEET A101. CONSTRUCTION WORK IS LIMITED TO REAR DOOR OF WORK AREA ONLY. CORRIDOR DOOR SHALL REMAIN IN PLACE AND UNACCESSIBLE DURING CONSTRUCTION.

PLAN LEGEND: Symbols for wall-mounted fire extinguisher on bracket, 2-hour fire wall assembly, and 1-hour fire barrier assembly.




ROOM CAPACITY: POSTED OCCUPANT LOAD - ALL ROOMS THAT ARE EXISTING, RENOVATED OR CONSTRUCTED AS ADDITIONS UNDER THE NJ REHABILITATION SUBCODE SHALL HAVE POSTED OCCUPANT LOAD SIGNS.

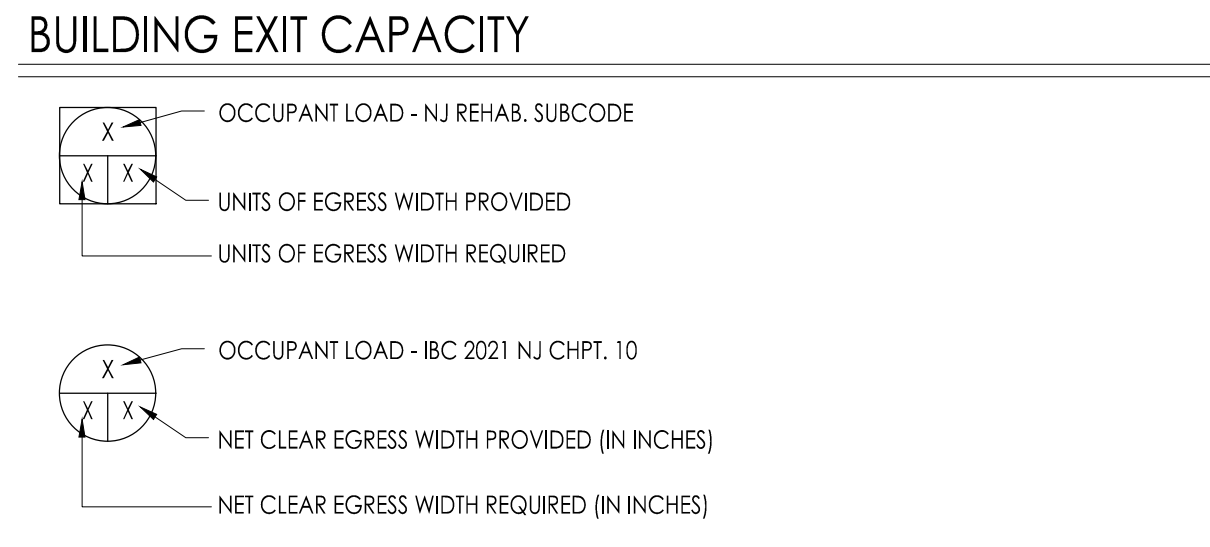

SYMBOL LIST: Key symbols for drawing elements like section numbers, wall sections, detail numbers, demolition notes, window/curtain wall types, door numbers, borrowed light, room names, equipment numbers, and interior elevations.

MATERIAL LEGEND: Hatched patterns representing materials such as ACB, I.A.C.T., CMU, EARTH, POROUS FILL, PLASTER / GYP BD / EIFS, CONCRETE, STUD PARTITION, BATT INSULATION, ROUGH WOOD, PLYWOOD, FINISH WOOD, FACE BRICK, METAL / STEEL, and RIGID INSULATION.

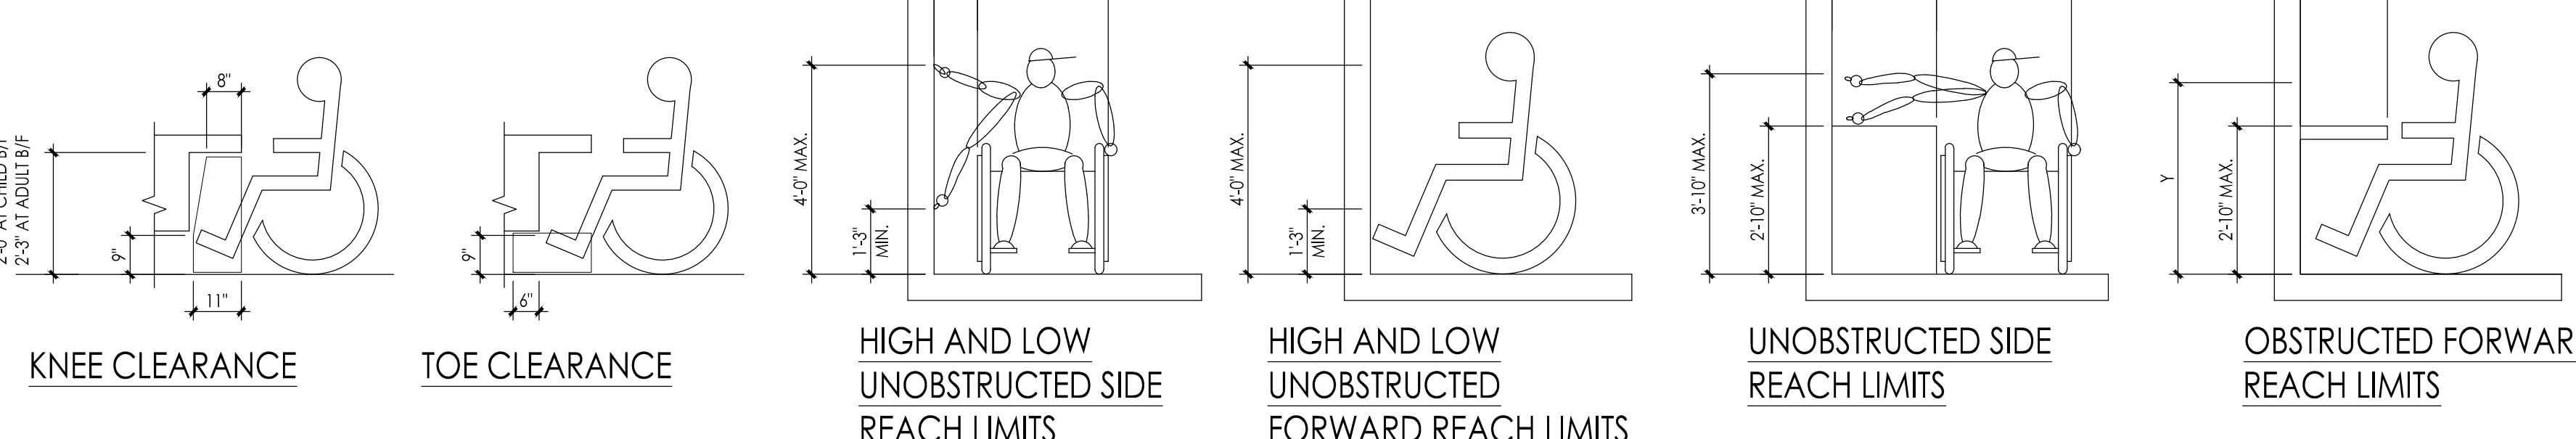

Project information and firm logo: FVHHD architects planners, Fraytak Veisz Hopkins Dutchie P.C., 140 Whittaker Ave - Mont Clare - Pennsylvania 19403.

Project details: Project Name (STEM Lab Alterations & Renovations at Clearview Regional Middle School), Project Owner Name (Clearview Regional High School District), Project Location (595 Jefferson Rd, Mullica Hill, NJ 08062), Project Number (5162C), Project Date (10/11/2023), Checked By (GRD), Drawn By (SB), Scale (AS NOTED).


Drawing Name: GENERAL NOTES, DRAWING INDEX, AND ABBREVIATION LIST

Revisions table with columns: No., Date, Description. Revision 1: 10.20.23 ADDENDUM 1.

Drawing Number: G002

Revisions

No.	Date	Description
1	10.20.23	ADDENDUM 1

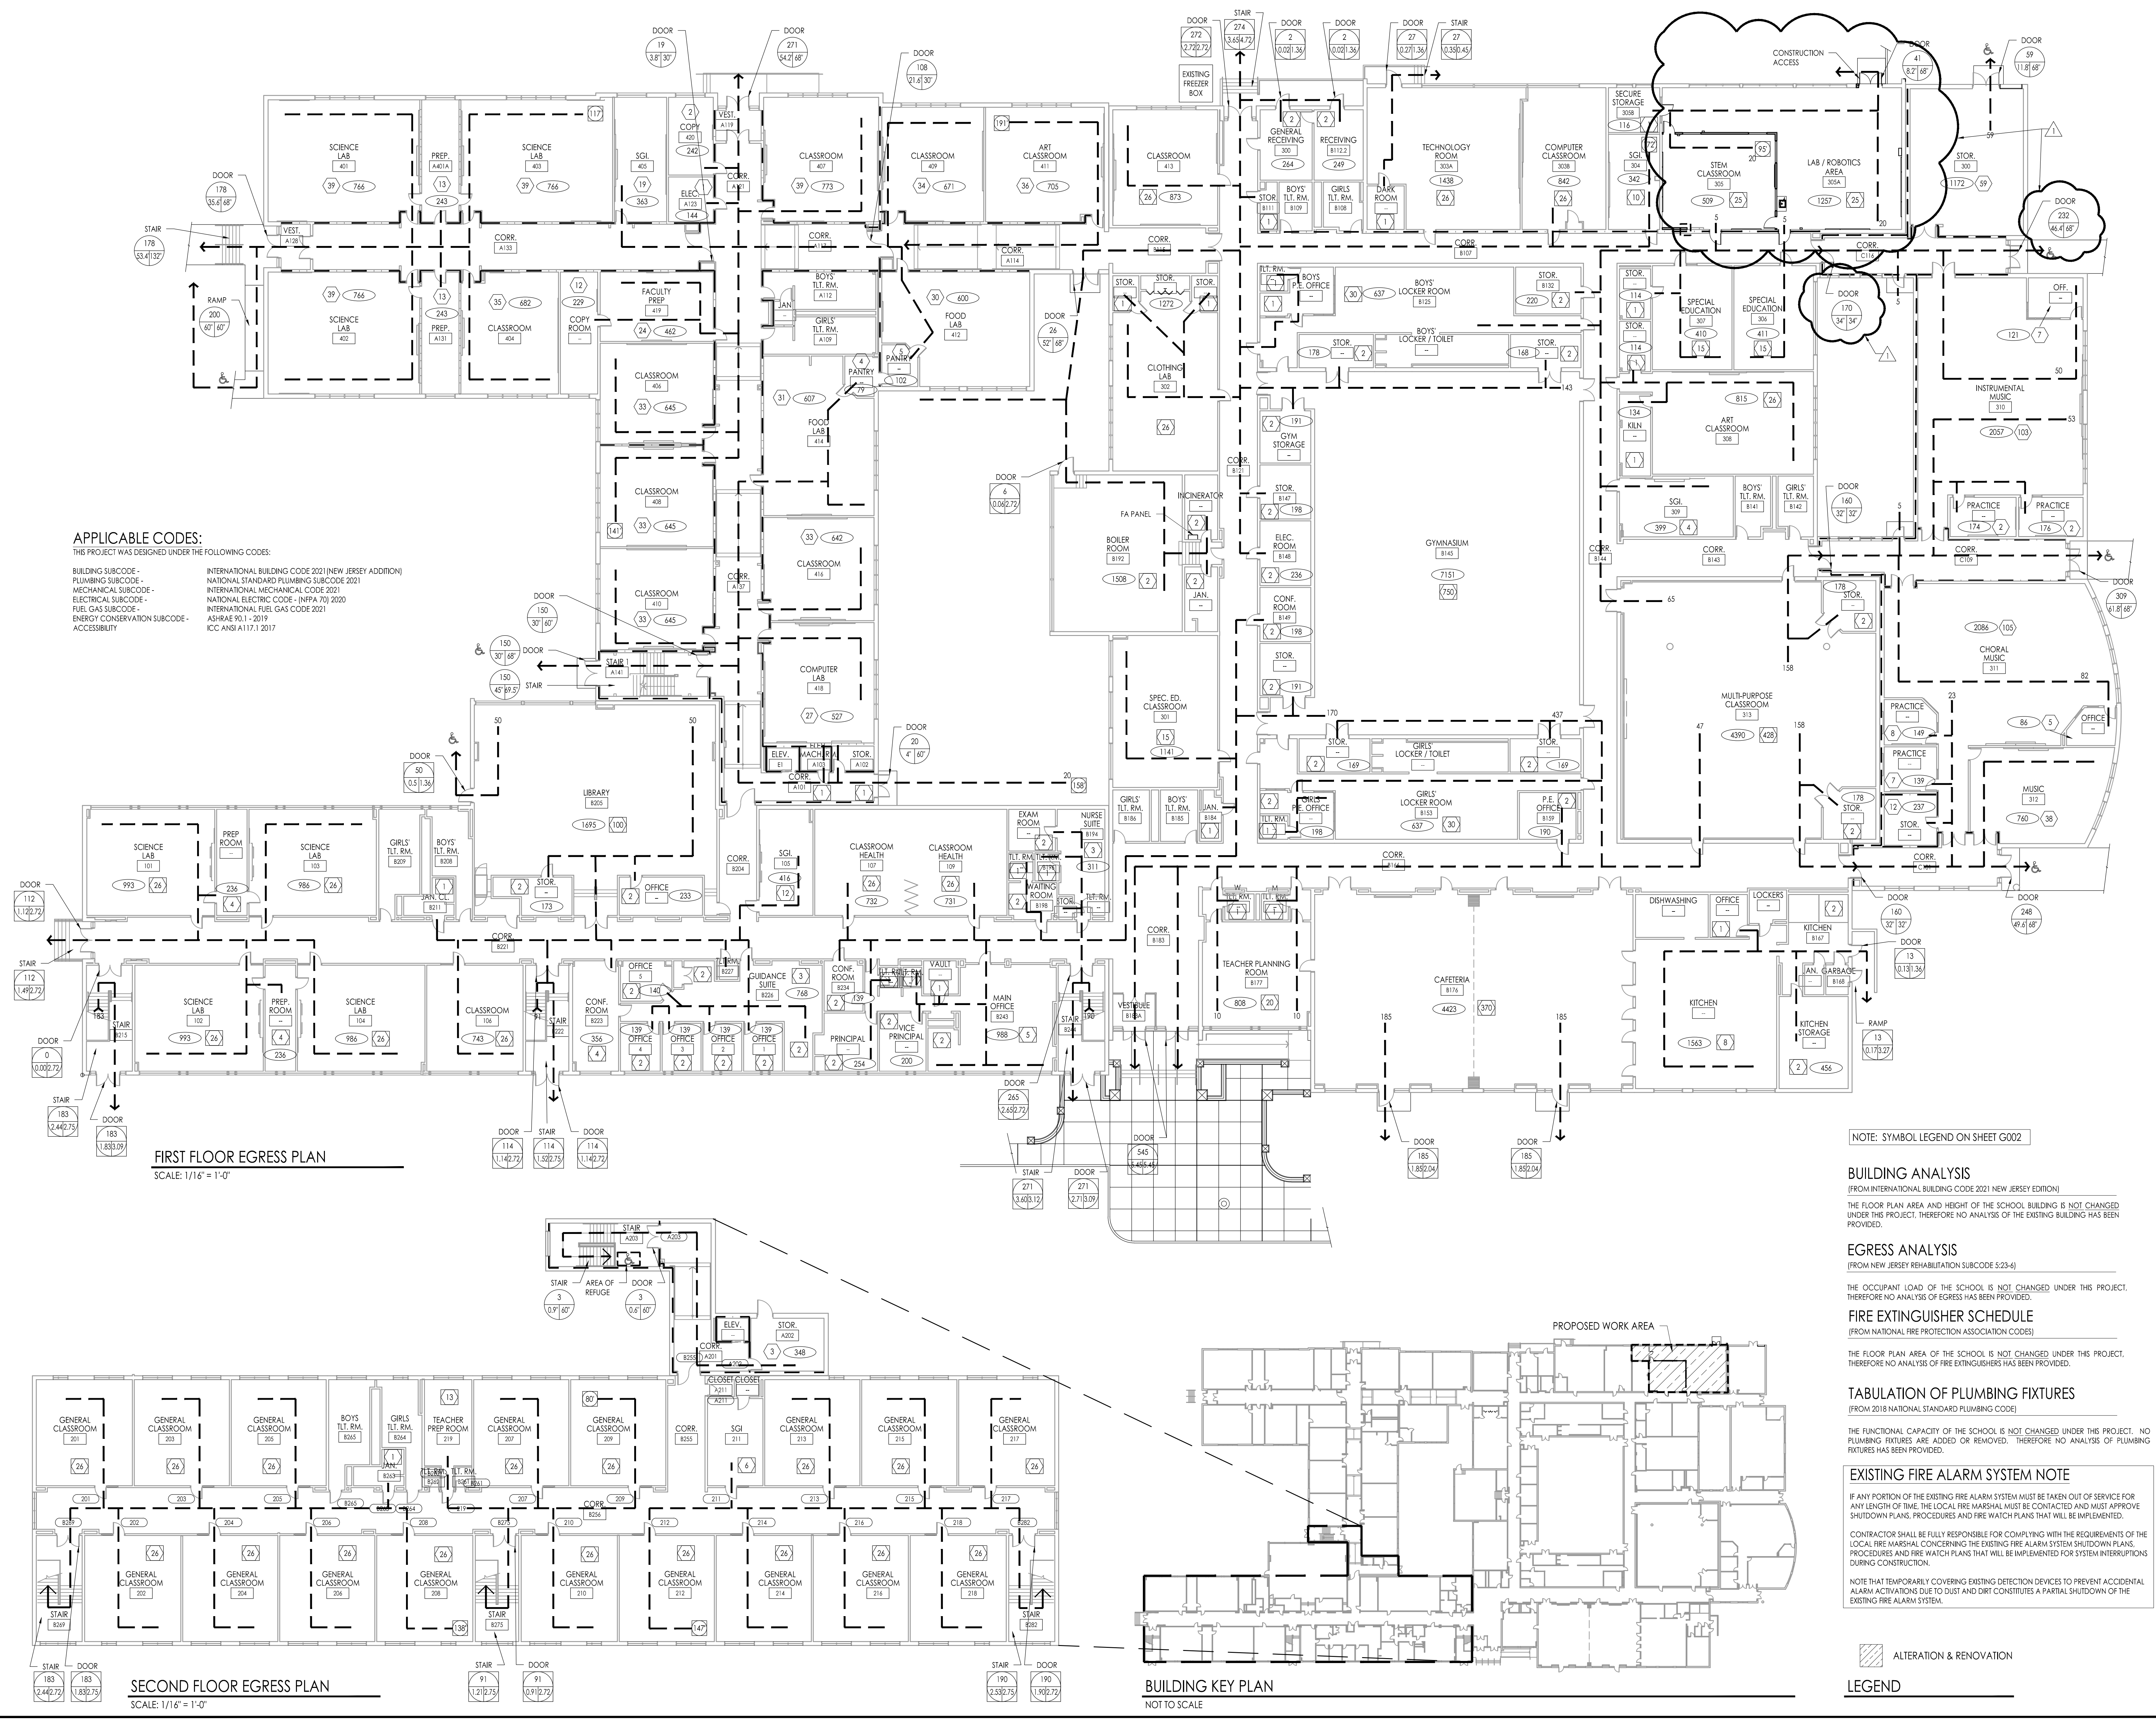

APPLICABLE CODES:
 THIS PROJECT WAS DESIGNED UNDER THE FOLLOWING CODES:
 BUILDING SUBCODE - INTERNATIONAL BUILDING CODE 2021 (NEW JERSEY ADDITION)
 PLUMBING SUBCODE - NATIONAL STANDARD PLUMBING SUBCODE 2021
 MECHANICAL SUBCODE - INTERNATIONAL MECHANICAL CODE 2021
 ELECTRICAL SUBCODE - NATIONAL ELECTRICAL CODE - (NFPA 70) 2020
 FUEL GAS SUBCODE - INTERNATIONAL FUEL GAS CODE 2021
 ENERGY CONSERVATION SUBCODE - ASHRAE 90.1 - 2019
 ACCESSIBILITY - ICC ANS A117.1 2017

FIRST FLOOR EGRESS PLAN
 SCALE: 1/16" = 1'-0"

SECOND FLOOR EGRESS PLAN
 SCALE: 1/16" = 1'-0"

BUILDING KEY PLAN
 NOT TO SCALE

NOTE: SYMBOL LEGEND ON SHEET G002

BUILDING ANALYSIS
 (FROM INTERNATIONAL BUILDING CODE 2021 NEW JERSEY EDITION)
 THE FLOOR PLAN AREA AND HEIGHT OF THE SCHOOL BUILDING IS NOT CHANGED UNDER THIS PROJECT. THEREFORE NO ANALYSIS OF THE EXISTING BUILDING HAS BEEN PROVIDED.

EGRESS ANALYSIS
 (FROM NEW JERSEY REHABILITATION SUBCODE S:23-6)
 THE OCCUPANT LOAD OF THE SCHOOL IS NOT CHANGED UNDER THIS PROJECT. THEREFORE NO ANALYSIS OF EGRESS HAS BEEN PROVIDED.

FIRE EXTINGUISHER SCHEDULE
 (FROM NATIONAL FIRE PROTECTION ASSOCIATION CODES)
 THE FLOOR PLAN AREA OF THE SCHOOL IS NOT CHANGED UNDER THIS PROJECT. THEREFORE NO ANALYSIS OF FIRE EXTINGUISHERS HAS BEEN PROVIDED.

TABULATION OF PLUMBING FIXTURES
 (FROM 2018 NATIONAL STANDARD PLUMBING CODE)
 THE FUNCTIONAL CAPACITY OF THE SCHOOL IS NOT CHANGED UNDER THIS PROJECT. NO PLUMBING FIXTURES ARE ADDED OR REMOVED. THEREFORE NO ANALYSIS OF PLUMBING FIXTURES HAS BEEN PROVIDED.

EXISTING FIRE ALARM SYSTEM NOTE
 IF ANY PORTION OF THE EXISTING FIRE ALARM SYSTEM MUST BE TAKEN OUT OF SERVICE FOR ANY LENGTH OF TIME, THE LOCAL FIRE MARSHAL MUST BE CONTACTED AND MUST APPROVE SHUTDOWN PLANS, PROCEDURES AND FIRE WATCH PLANS THAT WILL BE IMPLEMENTED.
 CONTRACTOR SHALL BE FULLY RESPONSIBLE FOR COMPLYING WITH THE REQUIREMENTS OF THE LOCAL FIRE MARSHAL CONCERNING THE EXISTING FIRE ALARM SYSTEM SHUTDOWN PLANS, PROCEDURES AND FIRE WATCH PLANS THAT WILL BE IMPLEMENTED FOR SYSTEM INTERRUPTIONS DURING CONSTRUCTION.
 NOTE THAT TEMPORARILY COVERING EXISTING DETECTION DEVICES TO PREVENT ACCIDENTAL ALARM ACTIVATIONS DUE TO DUST AND DIRT CONSTITUTES A PARTIAL SHUTDOWN OF THE EXISTING FIRE ALARM SYSTEM.

LEGEND
 [Symbol] ALTERATION & RENOVATION

GENERAL ROOFING DEMOLITION NOTES:

- A. THE ROOFING CONTRACTOR SHALL BE RESPONSIBLE FOR ALL MECHANICAL AND ELECTRICAL DISCONNECTIONS AND RE-CONNECTIONS REQUIRED FOR THE INSTALLATION OF ALL WORK REQUIRED BY THE DOCUMENTS INCLUDING: REMOVAL, PROTECTION AND REINSTALLATION OF ALL EXISTING ROOF MOUNTED EQUIPMENT IF REQUIRED FOR REINSTALLATION, EXTEND OR REVERSE EXISTING ELECTRICAL CIRCUITS, DUCTWORK, ETC. THE ROOFING CONTRACTOR IS RESPONSIBLE TO NOTIFY AND COORDINATE WITH THE OWNER TO DE-ENERGIZE ALL ELECTRICAL EQUIPMENT PRIOR TO DISCONNECTION AND REMOVAL OF ALL ELECTRICAL AND MECHANICAL EQUIPMENT. ALL EXISTING CONDUIT AND GAS LINES SHALL BE RASSED TO FACILITATE NEW ROOFING INSTALLATION AND TO ACHIEVE AN 8" MINIMUM HEIGHT FROM FINISHED ROOF SURFACE. (PERFORM ALL WORK IN ACCORDANCE WITH N.F.P.A. 70 AND PROVIDE AND INSTALL DUCTWORK IN ACCORDANCE WITH S.M.A.C.N.A. GUIDELINES), RE-CHARGE ALL AC UNITS THAT WERE RASSED AND HAD THEIR BRING WOODRED AND ALSO PROVIDE NEW PIPE INSULATION.
- B. THE ROOFING CONTRACTOR SHALL VERIFY THE EXACT LOCATION, DIMENSION, CONDITION AND QUANTITY OF ALL ROOFTOP EQUIPMENT AND APPURTENANCES WHICH INCLUDES, BUT ARE NOT LIMITED TO: EXHAUST FANS, VENT PIPES, DRAINS, HATCHES, FLUE PIPES, HOT STACKS, HVAC EQUIPMENT, CURBS, BASE FLASHING AND OTHER PENETRATIONS AND WORK ASSOCIATED WITH THIS ROOF PROJECT. (INCORPORATE SAME IN THE ROOF INSULATION SHOP DRAWING SUBMITTAL.)
- C. THE ROOFING CONTRACTOR SHALL BE RESPONSIBLE TO PERFORM DEMOLITION CAREFULLY CAUSING NO DAMAGE TO EXISTING CONSTRUCTION TO REMAIN. ANY DAMAGES MUST BE REPAIRED AND OR REPLACED BY THE ROOFING CONTRACTOR TO THE OWNER'S AND ARCHITECT'S SATISFACTION AND AT NO ADDITIONAL COST TO THE CONTRACT PRICE. PRIOR TO THE COMMENCEMENT OF WORK, THE ROOFING CONTRACTOR IS RESPONSIBLE TO INSPECT AND PHOTOGRAPH EXISTING CONDITIONS WHICH COULD BE MISCONSTRUCTED AS DAMAGE RESULTING FROM DEMOLITION AND INSTALLATION WORK.
- D. FOR PURPOSES OF THIS PROJECT, REMOVE SHALL MEAN REMOVE AND DISPOSE OF SAME OFF SITE IN AN APPROVED AND LEGAL MANNER.
- E. THE ROOFING CONTRACTOR SHALL COORDINATE ALL DUMPSTER STAGING AND TRUCK ROUTES WITH THE OWNER. THE ROOFING CONTRACTOR SHALL PROTECT ALL EXISTING PAVED AND PLANTED AREAS. THE ROOFING CONTRACTOR SHALL REPAIR ANY PAVED OR PLANTED AREAS TO THE SATISFACTION OF THE OWNER. THE REPAIRS ARE TO INCLUDE, BUT ARE NOT LIMITED TO: REPAIRS OF ASPHALT DRIVEWAYS AND PARKING LOTS, REGRADING AND SEEDING OF LAWN, AND REPLACING DAMAGED PLANTS, SHRUBS, ETC. ALL REPAIRS AND RESTORATIONS SHALL BE DONE AT NO ADDITIONAL COST TO THE CONTRACT PRICE.
- F. IF THE BUILDING IS OCCUPIED, THE ROOFING CONTRACTOR IS SOLELY RESPONSIBLE FOR ALL MEANS AND METHODS OF CONSTRUCTION AND FOR THE SAFETY OF ALL PERSONS AT THE PROJECT SITE.
- G. IF THE PRESENCE OF ASBESTOS IS SUSPECTED, THE CONTRACTOR IS TO NOTIFY THE OWNER AND ARCHITECT IMMEDIATELY. IF THE PRESENCE OF ASBESTOS IS CONFIRMED, THE CONTRACTOR IS RESPONSIBLE FOR MEANS REQUIRED TO PREVENT ANY HAZARDOUS MATERIAL FROM ENTERING INTO THE BUILDING. CONTRACTOR IS TO REMOVE AND DISPOSE OF SAID ASBESTOS IN FULL COMPLIANCE WITH THE REQUIREMENTS OF ALL AUTHORITIES HAVING JURISDICTION RELATING TO THE TREATMENT, REMOVAL AND DISPOSAL OF ASBESTOS.

GENERAL CONSTRUCTION NOTES

- A. PROVIDE ROOFING MATERIALS THAT COMPLY WITH THE EXISTING SYSTEM. SEE ROOF WARRANTY #132303 BY TREMCO FOR SYSTEM TYPE.
- B. NEW IMPOSED DEAD LOAD IS EQUAL TO OR LESS THAN EXISTING DEAD LOAD.
- C. INSTALL WATER DIVERTING CRICKETS ON HIGH SIDE OF ROOF AT ROOFTOP UNITS, CURBS AND SKYLIGHTS AS SHOWN ON PLAN.
- D. FRIT WOOD BLOCKING SHOWN ON DRAWINGS IS DIAGRAMMATIC. PROVIDE FIRE RETARDANT TREATED WOOD BLOCKING CONSTRUCTION IN THICKNESS AND HEIGHT TO MATCH THICKNESS OF INSULATION AND/OR TAPERED INSTALLATION AS RECOMMENDED BY ROOFING MANUFACTURER AND TO MAINTAIN A CONSTANT ROOF EDGE. ELEVATION IN A HORIZONTAL PLANE UNLESS NOTED OTHERWISE. AT ROOF EDGES PROVIDE AN ADDITIONAL FRIT 2 X 6 ABOVE INSULATION AND/OR TAPERED INSTALLATION.
- E. ALL WORK PERTAINING TO THESE DRAWINGS SHALL BE PERFORMED IN ACCORDANCE WITH ALL APPLICABLE STATE AND LOCAL CODES AND WITH ALL AGENCIES HAVING JURISDICTION.
- F. ALL CONDITIONS MEETING THE ROOF SURFACE PERPENDICULAR MUST BE MODIFIED TO CREATE A MINIMUM 8" FLASHING HEIGHT. CURBS AND WALL COUNTER FLASHINGS MUST BE RASSED.
- G. DO NOT SCALE THE DRAWINGS.
- H. ALL LOW SLOPED ROOF AREAS ARE 1/2" PER FOOT IN THE FIELD AND 1/4" PER FOOT AT THE CRICKETS. SLOPE OF CRICKET IS PERPENDICULAR TO CRICKET +2 VALLEY LINE.
- I. THE ROOFING CONTRACTOR IS RESPONSIBLE FOR FOLLOWING ALL GOOD ROOFING PRACTICES INCLUDING THOSE SET FORTH BY THE ROOFING MATERIALS MANUFACTURER, THE SHIMONA SHEET METAL MANUAL, FACTORY MUTUAL, UNDERWRITERS LABORATORIES, AND THE NRCA'S ROOFING AND WATERPROOFING MANUAL.
- J. THE ROOFING CONTRACTOR IS RESPONSIBLE FOR FLASHING ALL ROOF TOP PENETRATIONS, UNITS, AND CURBS ON THE ROOFTOP TO A WATERIGHT CONDITION TO BE INCLUDED IN THE MANUFACTURER'S WARRANTY. REVIEW ALL DRAWINGS INCLUDED IN THIS SET FOR ROOFTOP PENETRATIONS.
- K. ALL CRICKETS/GUSSETS/SADDLES SHALL HAVE A 3:5 RATIO, WHERE THIS CONDITION CANNOT BE ACHIEVED DUE TO VALLEY LINE OF CRICKET INTERSECTING MECHANICAL EQUIPMENT, PENETRATION AND A HIGH POINT GREATER THAN THE THRU-WALL COUNTER FLASHING, PROVIDE MAXIMUM CRICKET WIDTH TO PROMOTE POSITIVE DRAINAGE TO ALL ROOF DRAINS AND SCUPPERS.
- L. UNLESS NOTED OTHERWISE ALL ROOFING, ACCESSORIES, MATERIALS, ETC. SHALL BE CONSIDERED NEW.
- M. HIGH POINTS INDICATED ON DRAWINGS ARE SHOWN FOR GUIDANCE ONLY. THE ROOFING CONTRACTOR IS RESPONSIBLE FOR FINAL TAPERED INSULATION DESIGN. ANY REQUIRED ADJUSTMENTS MADE BY THE ROOFING CONTRACTOR TO THE INDICATED DESIGN GUIDELINES ARE AT NO ADDITIONAL COST TO THE OWNER.
- N. ROOFING CONTRACTOR SHALL RETAIN A LICENSED ELECTRICAL SUBCONTRACTOR FOR ALL ELECTRICAL WORK.
- O. ROOFING CONTRACTOR SHALL RETAIN A LICENSED HVAC SUBCONTRACTOR FOR ALL HVAC WORK.
- P. 1. PRIME ALL SURFACES WHICH ARE TO RECEIVE BITUMINOUS ROOFING.
2. INSTALL ENVELOPE EDGES TO ELIMINATE THE POTENTIAL FOR BITUMEN AND ADHESIVE DRIPPAGE INTO THE BUILDING.
3. ALL WOOD BLOCKING TO BE FRIT, (FIRE RETARDANT LUMBER).
- Q. CONTRACTOR SHALL MAKE NECESSARY TEINS AND ALTERATIONS TO EXISTING ROOF IN ACCORDANCE WITH ORIGINAL ROOF MANUFACTURERS REQUIREMENTS, SO AS TO MAINTAIN ORIGINAL WARRANTY ON EXISTING ROOF.
- R. CONTRACTOR SHALL AT ALL TIMES HAVE A FULL SET OF DRAWINGS AND SPECIFICATIONS ON ROOF TOP WHILE WORK IS IN PROGRESS.
- S. CONTRACTOR RESPONSIBLE TO RECTIFY ANY PONDING WATER ON FINISHED ROOF SURFACE THAT REMAINS AFTER 48 HOURS AT NO ADDITIONAL COST.

DEMOLITION NOTES:

- 1. REMOVE EXISTING EQUIPMENT, CAP EXISTING CURB TO REMAIN. SEE MEP DRAWINGS FOR ADDITIONAL NOTES AND DETAILS.
- 2. MODIFY EXISTING OPENING OF GRAVITY VENT TO ACCOMMODATE NEW EQUIPMENT. THE CONTRACTOR IS TO TAKE ALL NECESSARY STEPS TO ENSURE WEATHERTIGHTNESS DURING THE COURSE OF THE WORK, PATCH AND REPAIR ALL DAMAGE CAUSED BY RENOVATION TO MATCH EXISTING ADJACENT SURFACES ACCORDING TO ROOFING MANUFACTURER.
- 3. DE-ENERGIZE, UNINSTALL PANELS AND ASSOCIATED CONDUITS AND APPURTENANCES AS SHOWN ON DRAWING OUTLINED. CONTRACTOR SHALL DETERMINE WHICH SECTION OF THE PANELS ARE TO BE REMOVED WITH OWNER BEFORE ANY REMOVAL AND THEN HAND OVER ALL EQUIPMENT TO OWNER. CONTRACTOR IS TO PATCH AND REPAIR ALL DAMAGES INCURRED BY THE REMOVAL OF THE SOLAR PANELS ACCORDING TO THE ROOFING MANUFACTURER.

CONSTRUCTION NOTES - SBS:

- 1. AT VENT PIPES, INSTALL LIQUID APPLIED FLASHING SYSTEM W/ FLEECE REINFORCING. INSTALL PER MANUFACTURES LATEST INSTALLATION GUIDELINES FLASHING SHALL BE INCLUDED IN ROOF MANUFACTURES WARRANTY SEE DETAIL 3/ A103. MODIFY/EXTEND ANY VENT PIPES THAT DO NOT MEET THE 8" MINIMUM BASE FLASHING HEIGHT.
- 2. AT ALL ROOFTOP EQUIPMENT ON FULLY ENCLOSED CURBS, ROOF HATCHES, & SKYLIGHTS, INSTALL ON WOOD BLOCKING WHICH HAS BEEN FASTENED TO THE ROOF DECK TO MAINTAIN 8" MINIMUM FLASHING HEIGHT FROM THE SURFACE OF THE ROOF. INSTALL INSULATION AND CANT STRIP. RUN ROOF MEMBRANE UP CURBS 2" ABOVE THE CANT STRIP. INSTALL SBS MODIFIED BITUMEN BASE FLASHING. FASTEN TOP EDGE AND INSTALL A REMOVABLE COUNTER FLASHING. SEE DETAIL 2/ A103 AND FOLLOW MFR'S LATEST INSTALLATION REQUIREMENTS. CURBS MUST ALSO BE SET LEVEL WHERE REQUIRED FOR PROPER FUNCTIONING OF THE ROOF TOP UNIT. PROVIDE 1/2" PER FOOT SLOPED TAPERED INSULATION CRICKETS AT HIGH SIDE OF NEW ROOFTOP EQUIPMENT. CRICKET SLOPE IS PERPENDICULAR TO SADDLE/CRICKET VALLEY LINE. ALL COLORS ARE SELECTED BY ARCH.
- 3. AT ALL REMOVED EQUIPMENT THAT WILL EXPOSE THE UNDERSIDE (INTERIOR), CAP EXISTING CURB AS SHOWN ON MEP'S DETAIL 3/H501.
- 4. EXG ROOF TO REMAIN ARE UNDER WARRANTY, INSTALLATION OF ROOFTOP EQUIPMENT IN THIS AREA SHALL BE DONE IN ACCORDANCE WITH THE ROOFING MANUFACTURES REQUIREMENTS TO MAINTAIN SAID WARRANTY. TYPICAL.
- 5. WALKWAY PADS - INSTALL AROUND ALL ROOFTOP UNITS, ROOFTOP EQUIPMENT AND ROOF ACCESS POINTS SUCH AS ACCESS LADDERS AND ROOF HATCHES. MODIFY WALKWAY PADS AS REQUIRED SO THAT THE PAD MUST NOT IMPEDE THE FREE FLOW OF WATER TO THE DRAINAGE POINTS. SEE DETAIL S/A103

SYMBOLS


- # DEMOLITION/ CONSTRUCTION NOTE
- # CONSTRUCTION NOTE
- SL DIRECTION OF ROOF SLOPE
- # ROOF ASSEMBLY TYPE
- 3/4" PER FOOT SLOPED TAPERED INSULATION CRICKETS

LEGEND


- EXG ROOF DRAIN
- TAPERED INSULATION
- ROOF DRAIN OVERFLOW ROOF DRAIN
- EXG GUTTER OUTLET AND RAIN WATER LEADER
- EXHAUST FAN UNIT
- PIPE CURB
- EXG SCUPPER BOX AND RAIN WATER LEADER
- HEAT STACK
- EXG OVERFLOW DRAIN
- VENTILATOR
- GOOSE NECK
- ROOF TOP UNIT
- VENT PIPE
- WALKWAY PADS
- ROOF HATCH
- PIPE SUPPORT
- RITCH POCKET
- SKYLIGHT
- ABANDON CURB TO BE REMOVED
- RIGID INSULATION
- ROOF INSULATION
- THERMAL BARRIER BOARD

SOLAR PANEL EQUIPMENT NOTE:

THE EXISTING SOLAR EQUIPMENT IS CURRENTLY OWNED BY THE SCHOOL DISTRICT AND NON-OPERATIONAL. THE GC IS TO REMOVE THE PANELS AND ASSOCIATED EQUIPMENT WITH CARE AND HAND OVER TO THE OWNER.

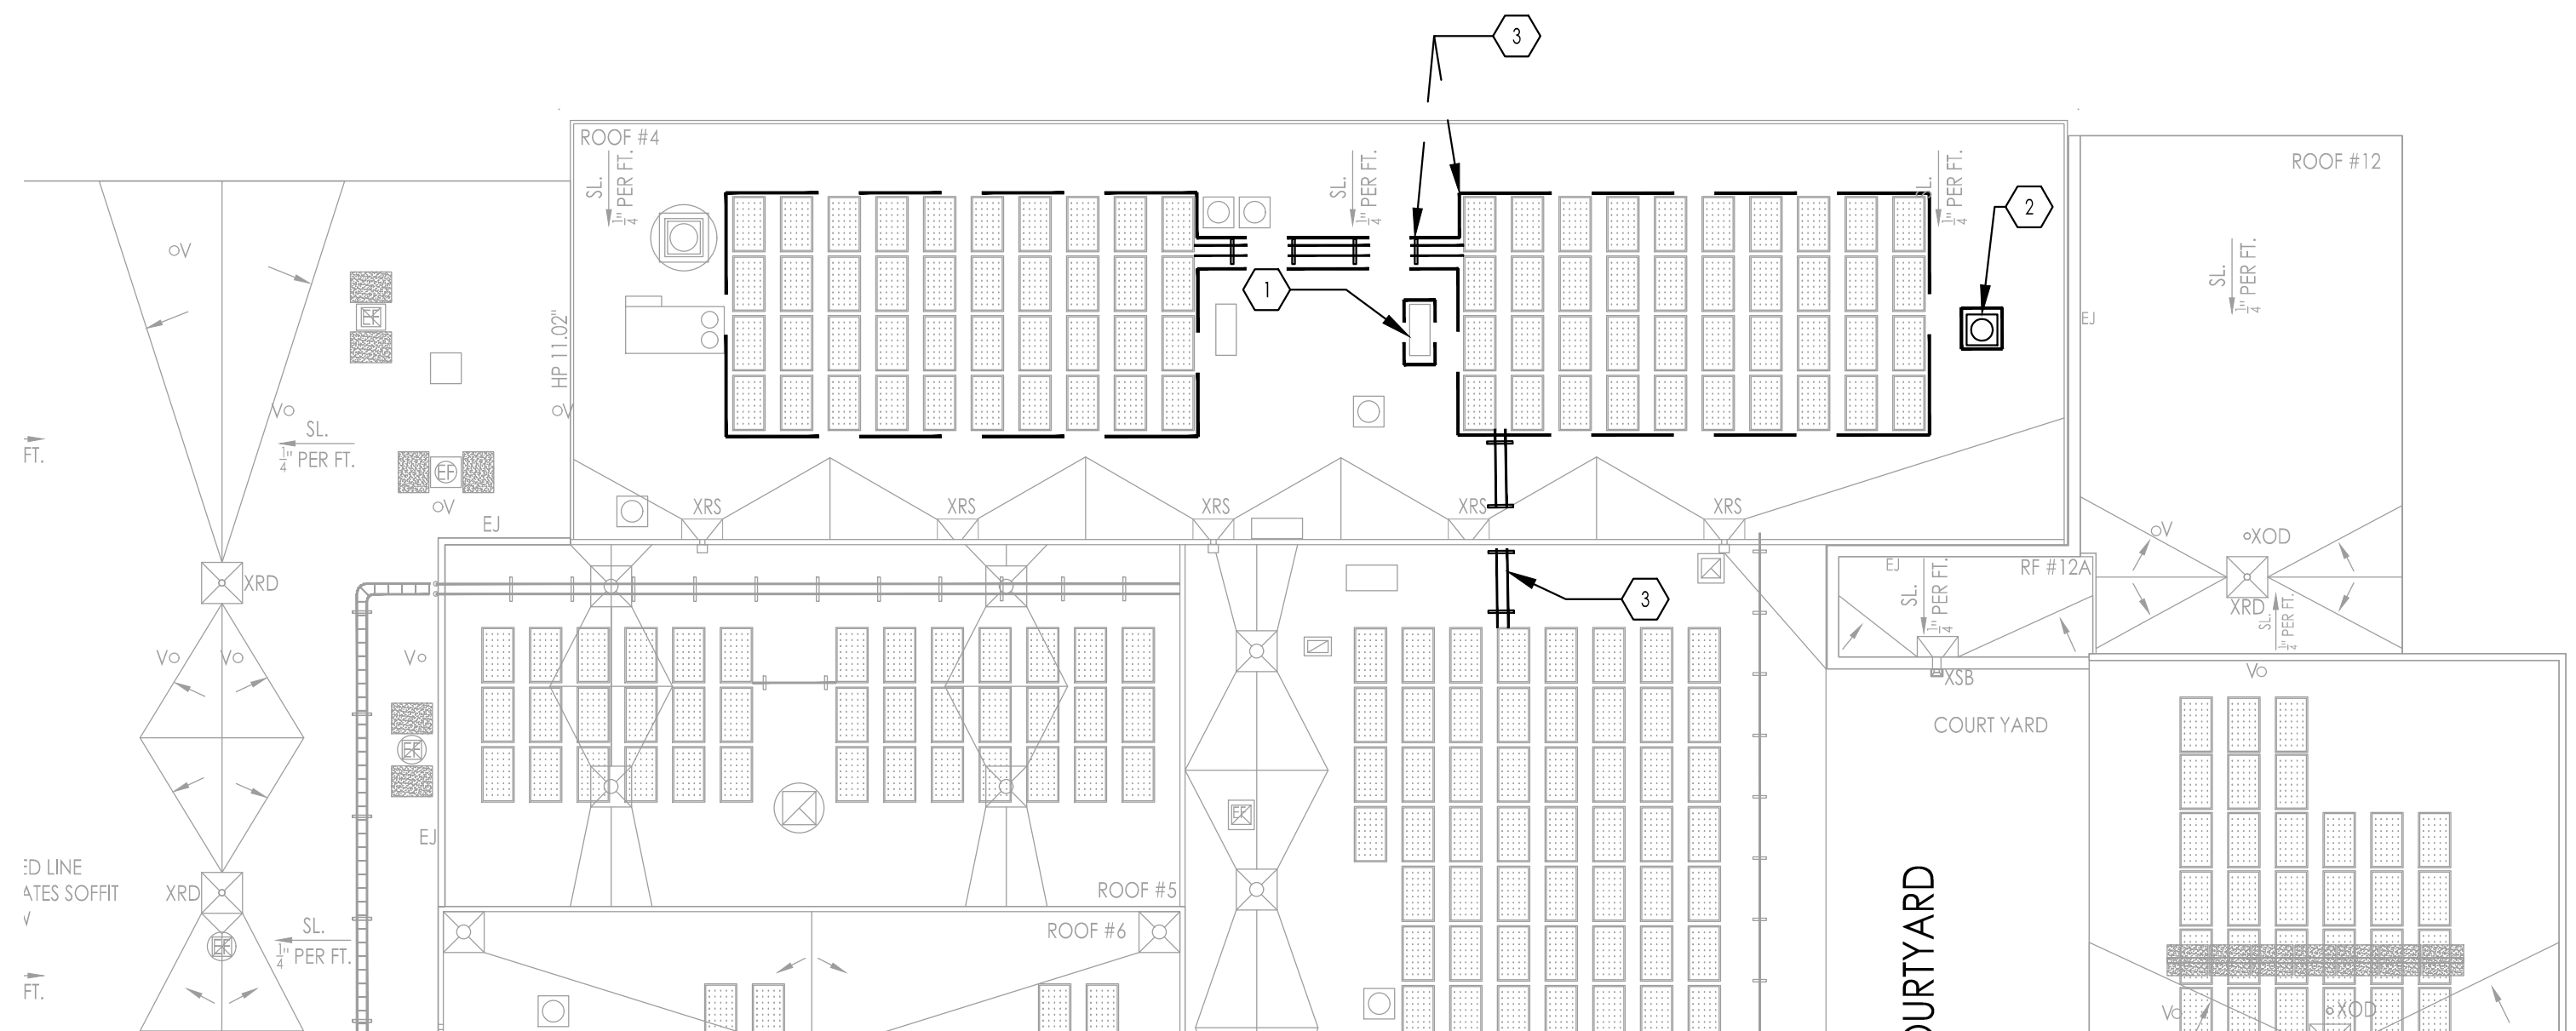


1 ROOF PLAN DEMOLITION
SCALE: 1/16" = 1' - 0"

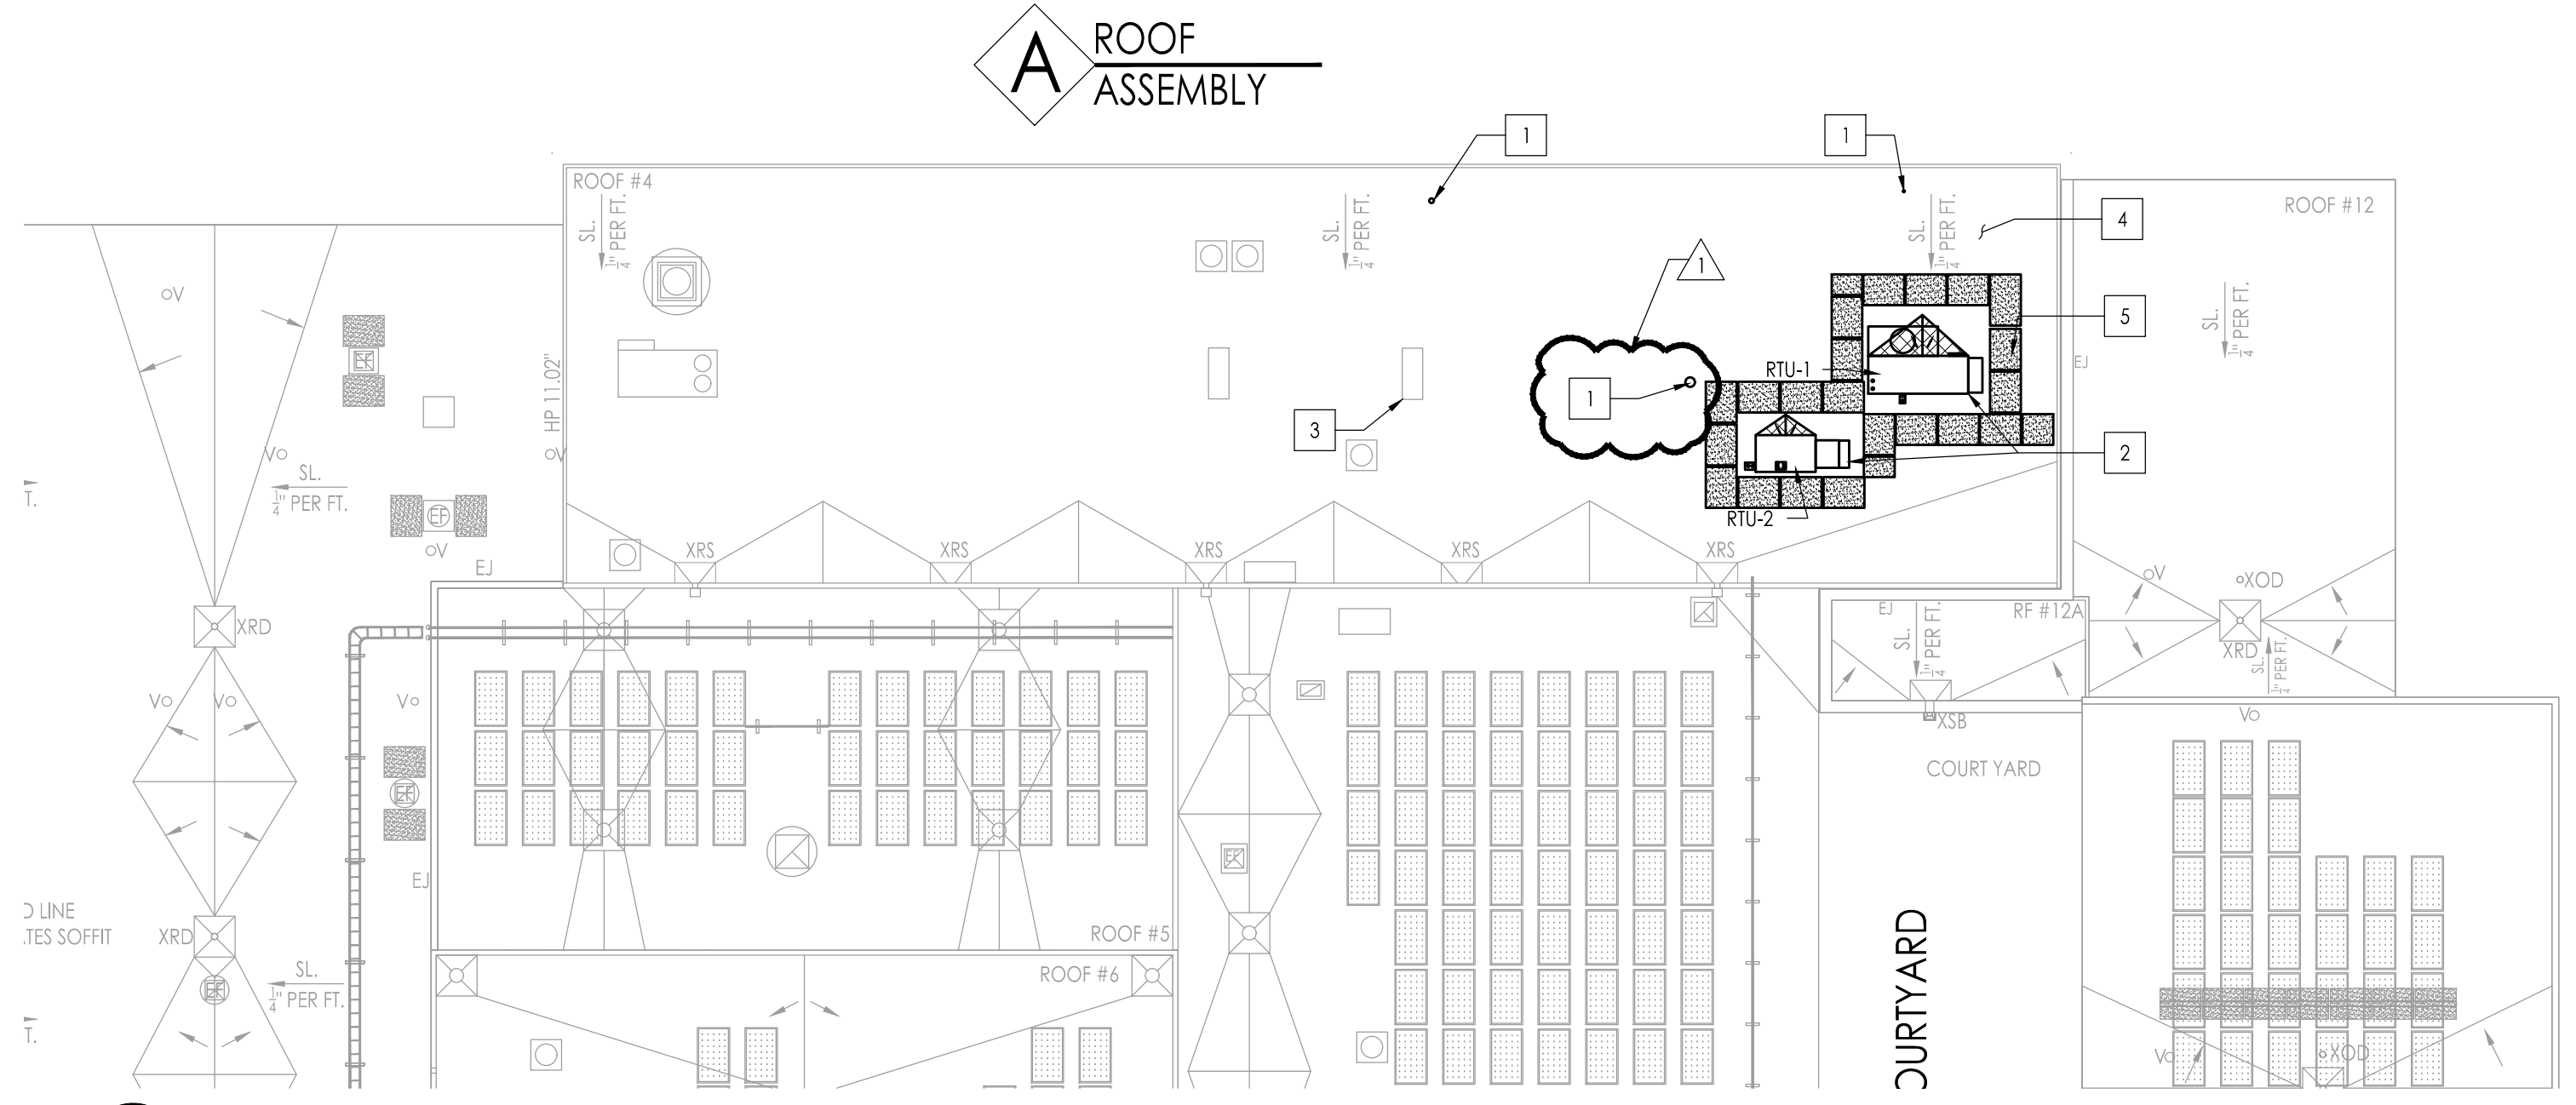


2 ROOF PLAN
SCALE: 1/16" = 1' - 0"

- NOTES**
- 1. BEFORE APPLICATION OF MEMBRANE RESIN AND REINFORCING FLEECE FLASHING MEMBRANE OR ELASTOMERIC SEALANT SHOULD BE USED TO FILL VOIDS WHERE ROOFING MEMBRANES TERMINATE AT PENETRATIONS.
 - 2. REFER TO MANUFACTURES PREPARATION GUIDELINES FOR PROPER SURFACE TREATMENT OF ALL MATERIALS PRIOR TO APPLICATION OF MEMBRANE RESIN AND REINFORCING FLEECE FLASHING.
 - 3. MEMBRANE RESIN AND REINFORCING FLEECE CANNOT BE APPLIED OVER MEMBRANE OR OTHER MATERIALS CONTAINING UNCURED, SOLVENT-BASED MATERIALS.
 - 4. REFER TO MANUFACTURES FLEECE CUTTING RECOMMENDATIONS FOR CONFIGURATIONS, CUTTING, FOLDING, AND LAPPING TECHNIQUES.


NOTE:
WHERE BASE FLASHING IS HIGHER THAN 24", TERMINATE SHEET WITH FASTENERS AND TERMINATION BAR. PRE-DRILL PRIOR TO INSTALLATION OF FASTENER RUN A SEPARATE SHEET UP ONTO THE REMAINING WALL SECTION. OVERLAP TERMINATION BAR A MINIMUM OF 6".

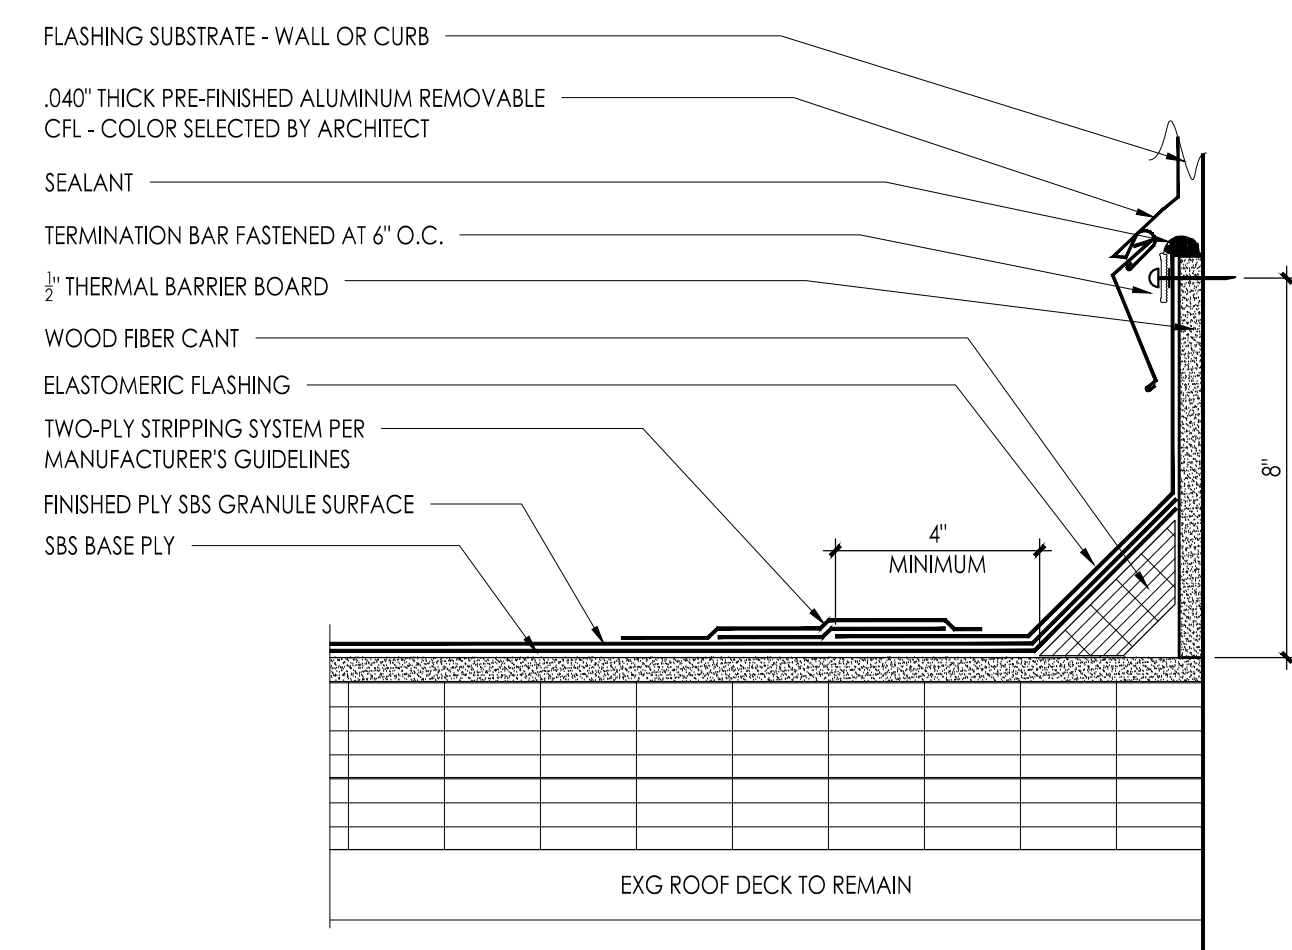


1 TYPICAL BASE FLASHING DETAIL
3" = 1'-0"

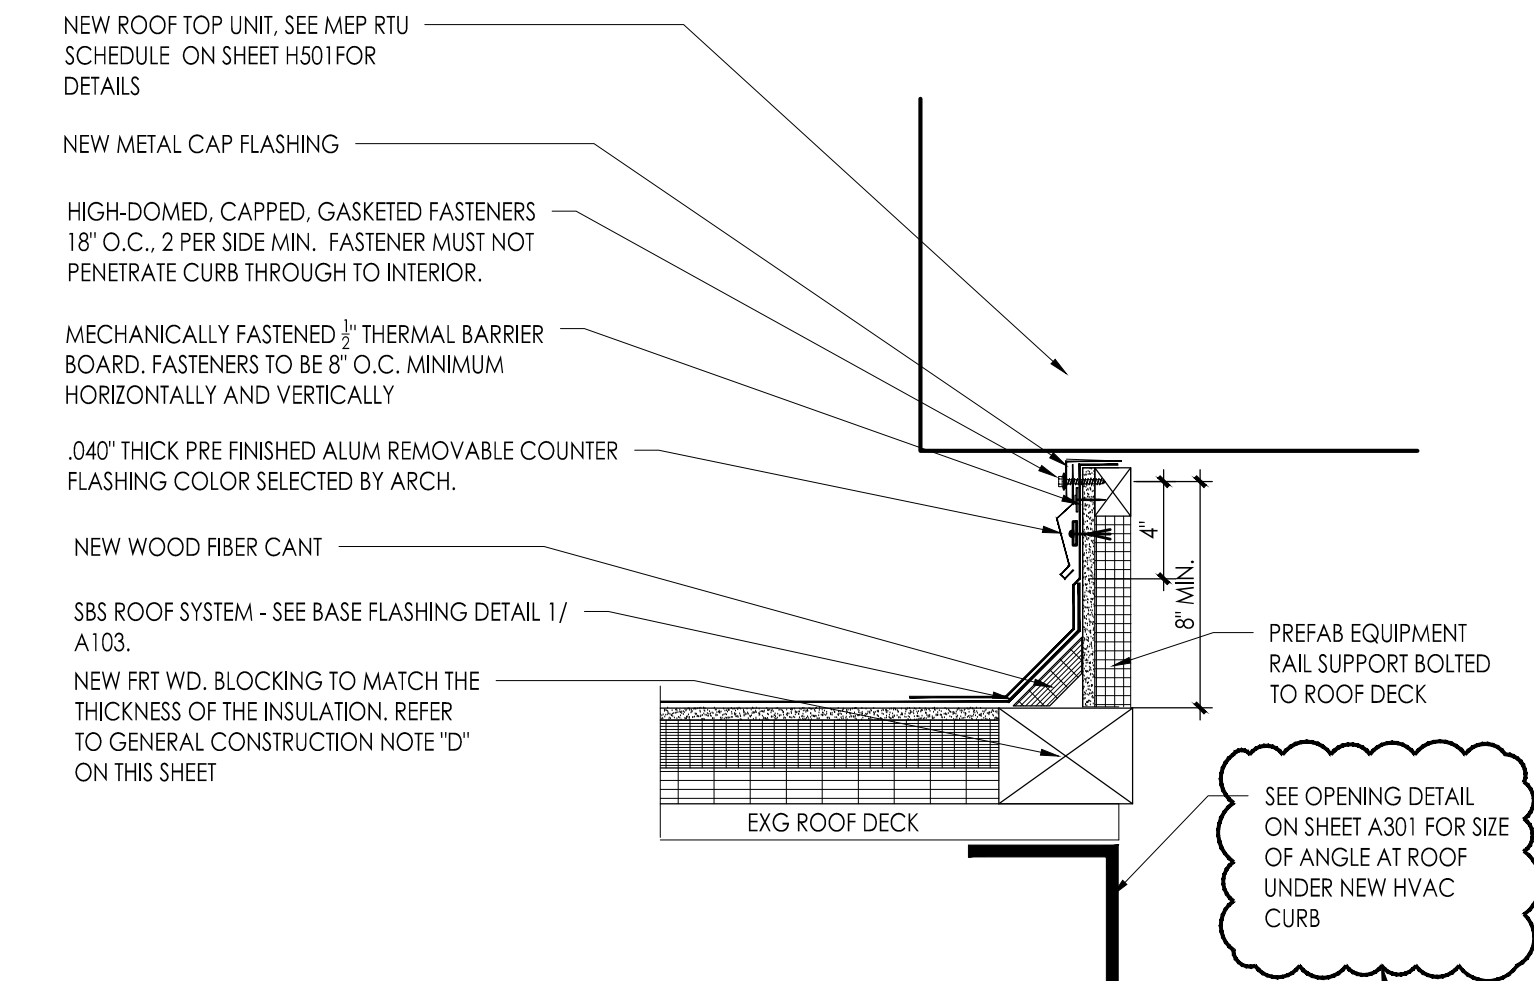


2 TYPICAL NEW ROOFTOP UNIT CURB DETAIL
1-1/2" = 1'-0"

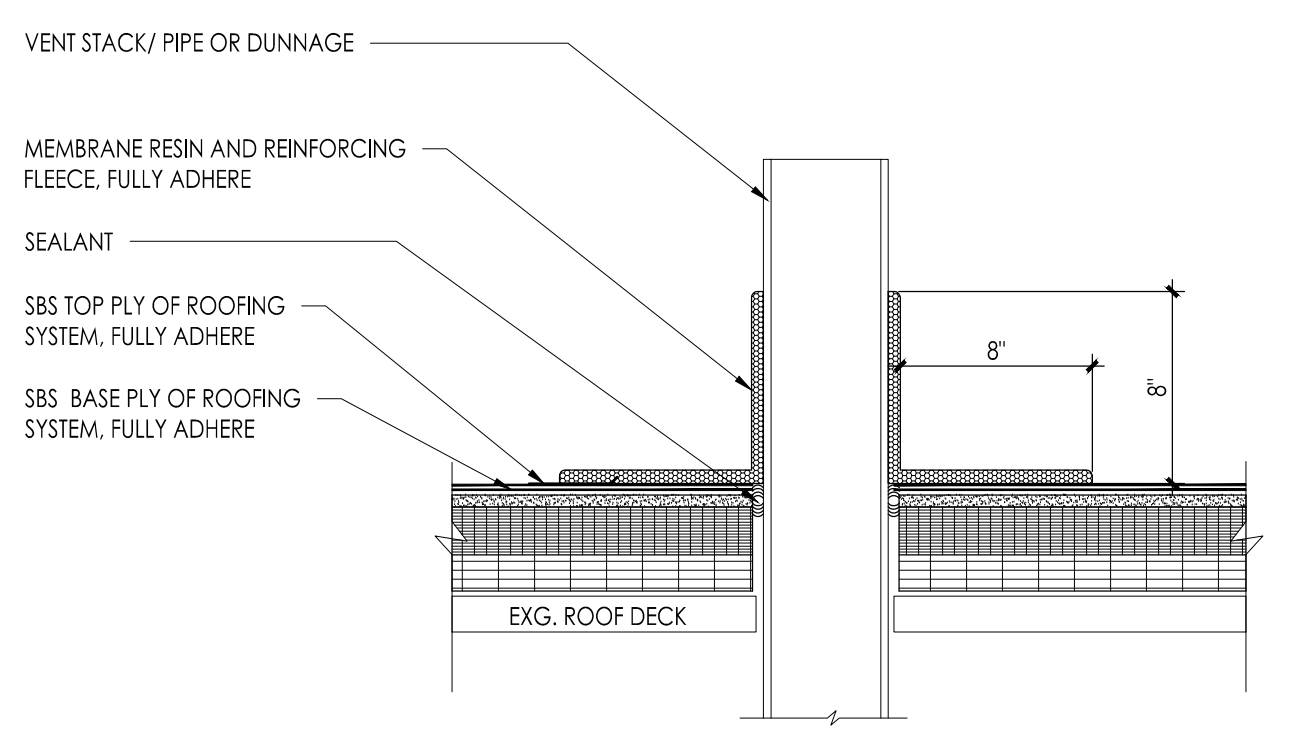


3 TYPICAL PVC PIPE/ DUNNAGE DETAIL
1-1/2" = 1'-0"

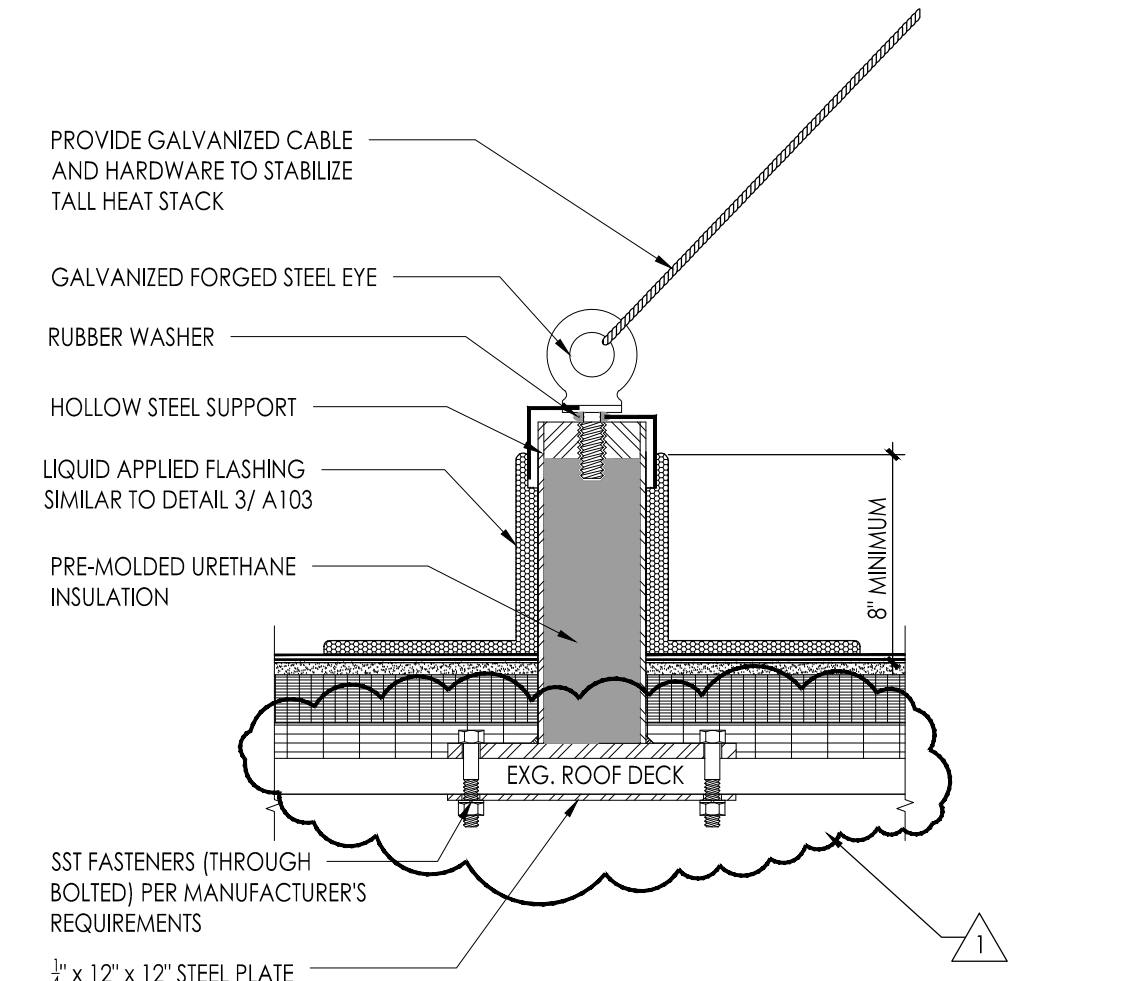

4 GUY WIRE SUPPORT DETAIL
NOT TO SCALE

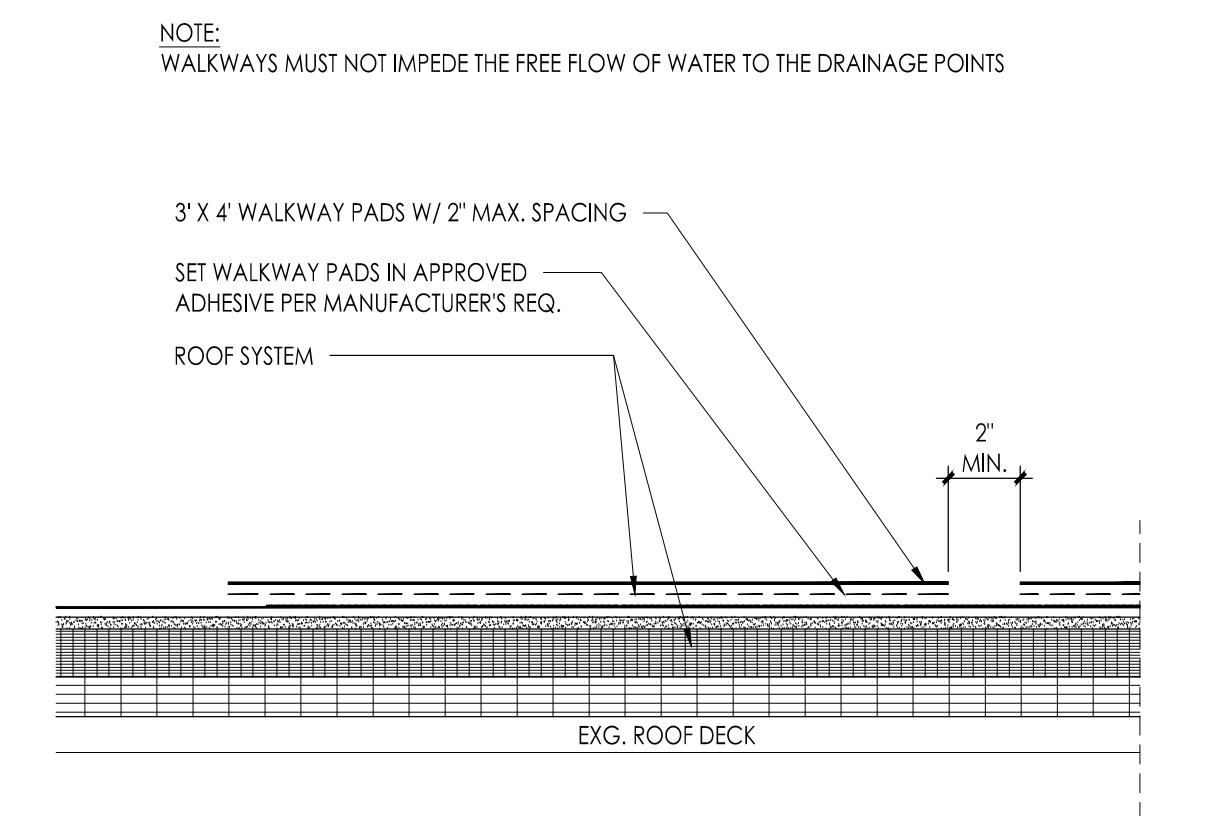

5 TYPICAL WALKWAY PAD
1-1/2" = 1'-0"

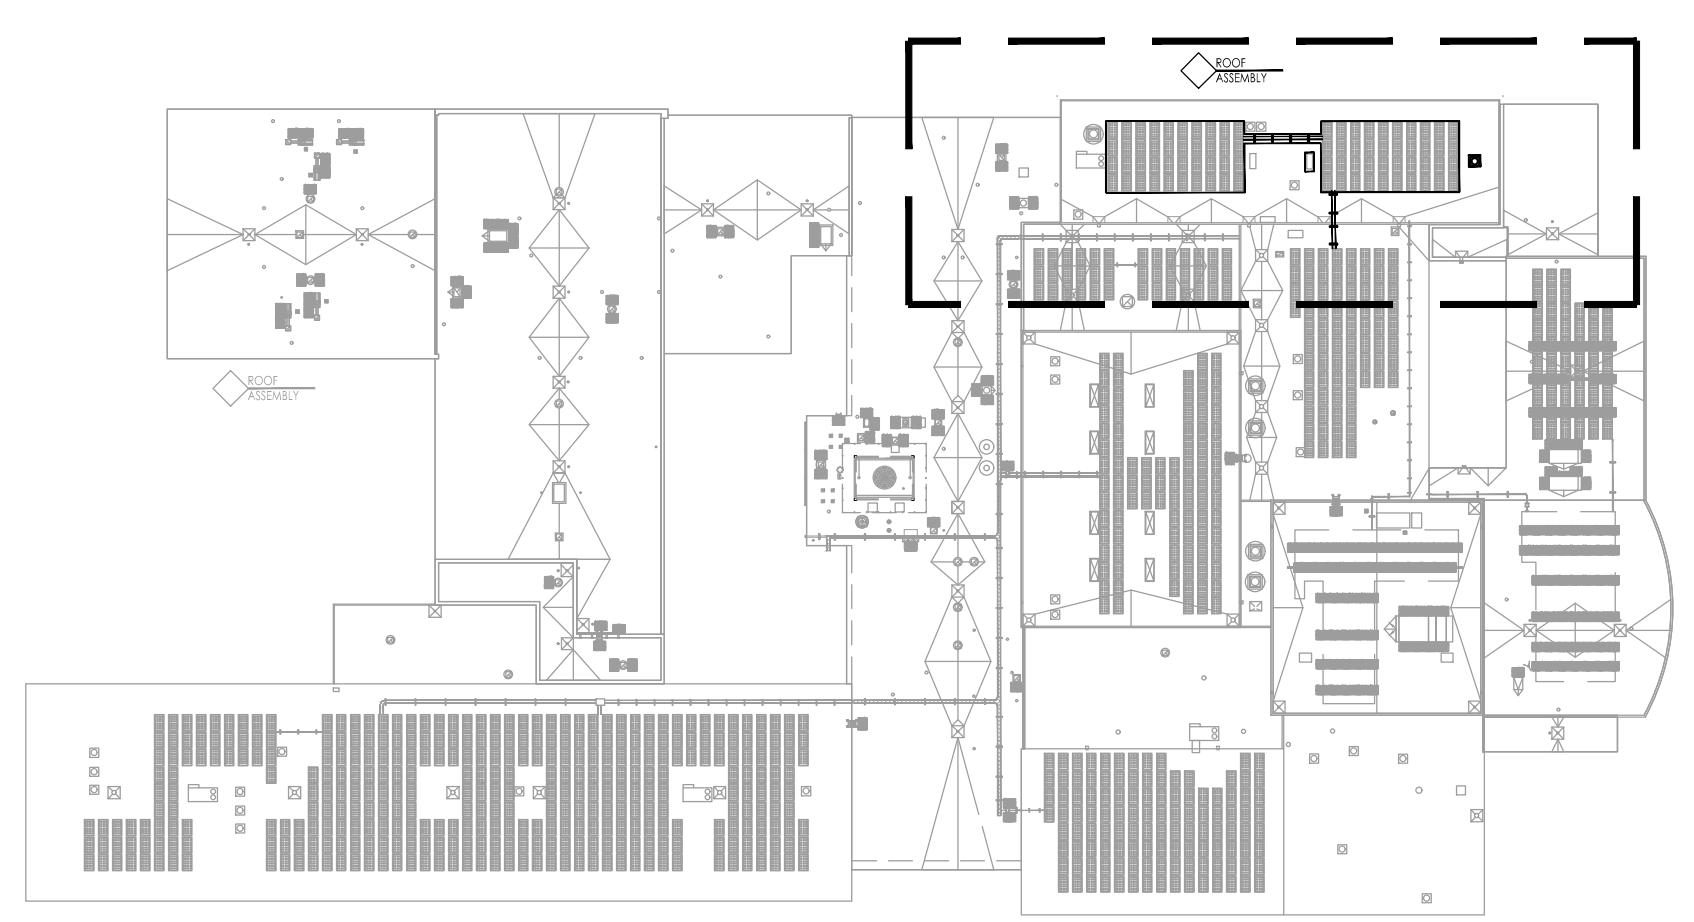

KEY PLAN
SCALE: 1/64" = 1' - 0"

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Project Name
STEM Lab Alterations & Renovations at Clearview Regional Middle School

Project Owner Name
Clearview Regional High School District


Project Location
595 Jefferson Rd, Mullica Hill, NJ 08062

Project Number
5162C
 Project Date
10/11/2023
 Checked By
GRD
 Drawn By
SB
 Scale
AS NOTED

Drawing Name
ROOF PLAN, DETAILS, AND NOTES

No.	Date	Description
1	10.20.23	ADDENDUM 1

Drawing Number
A103

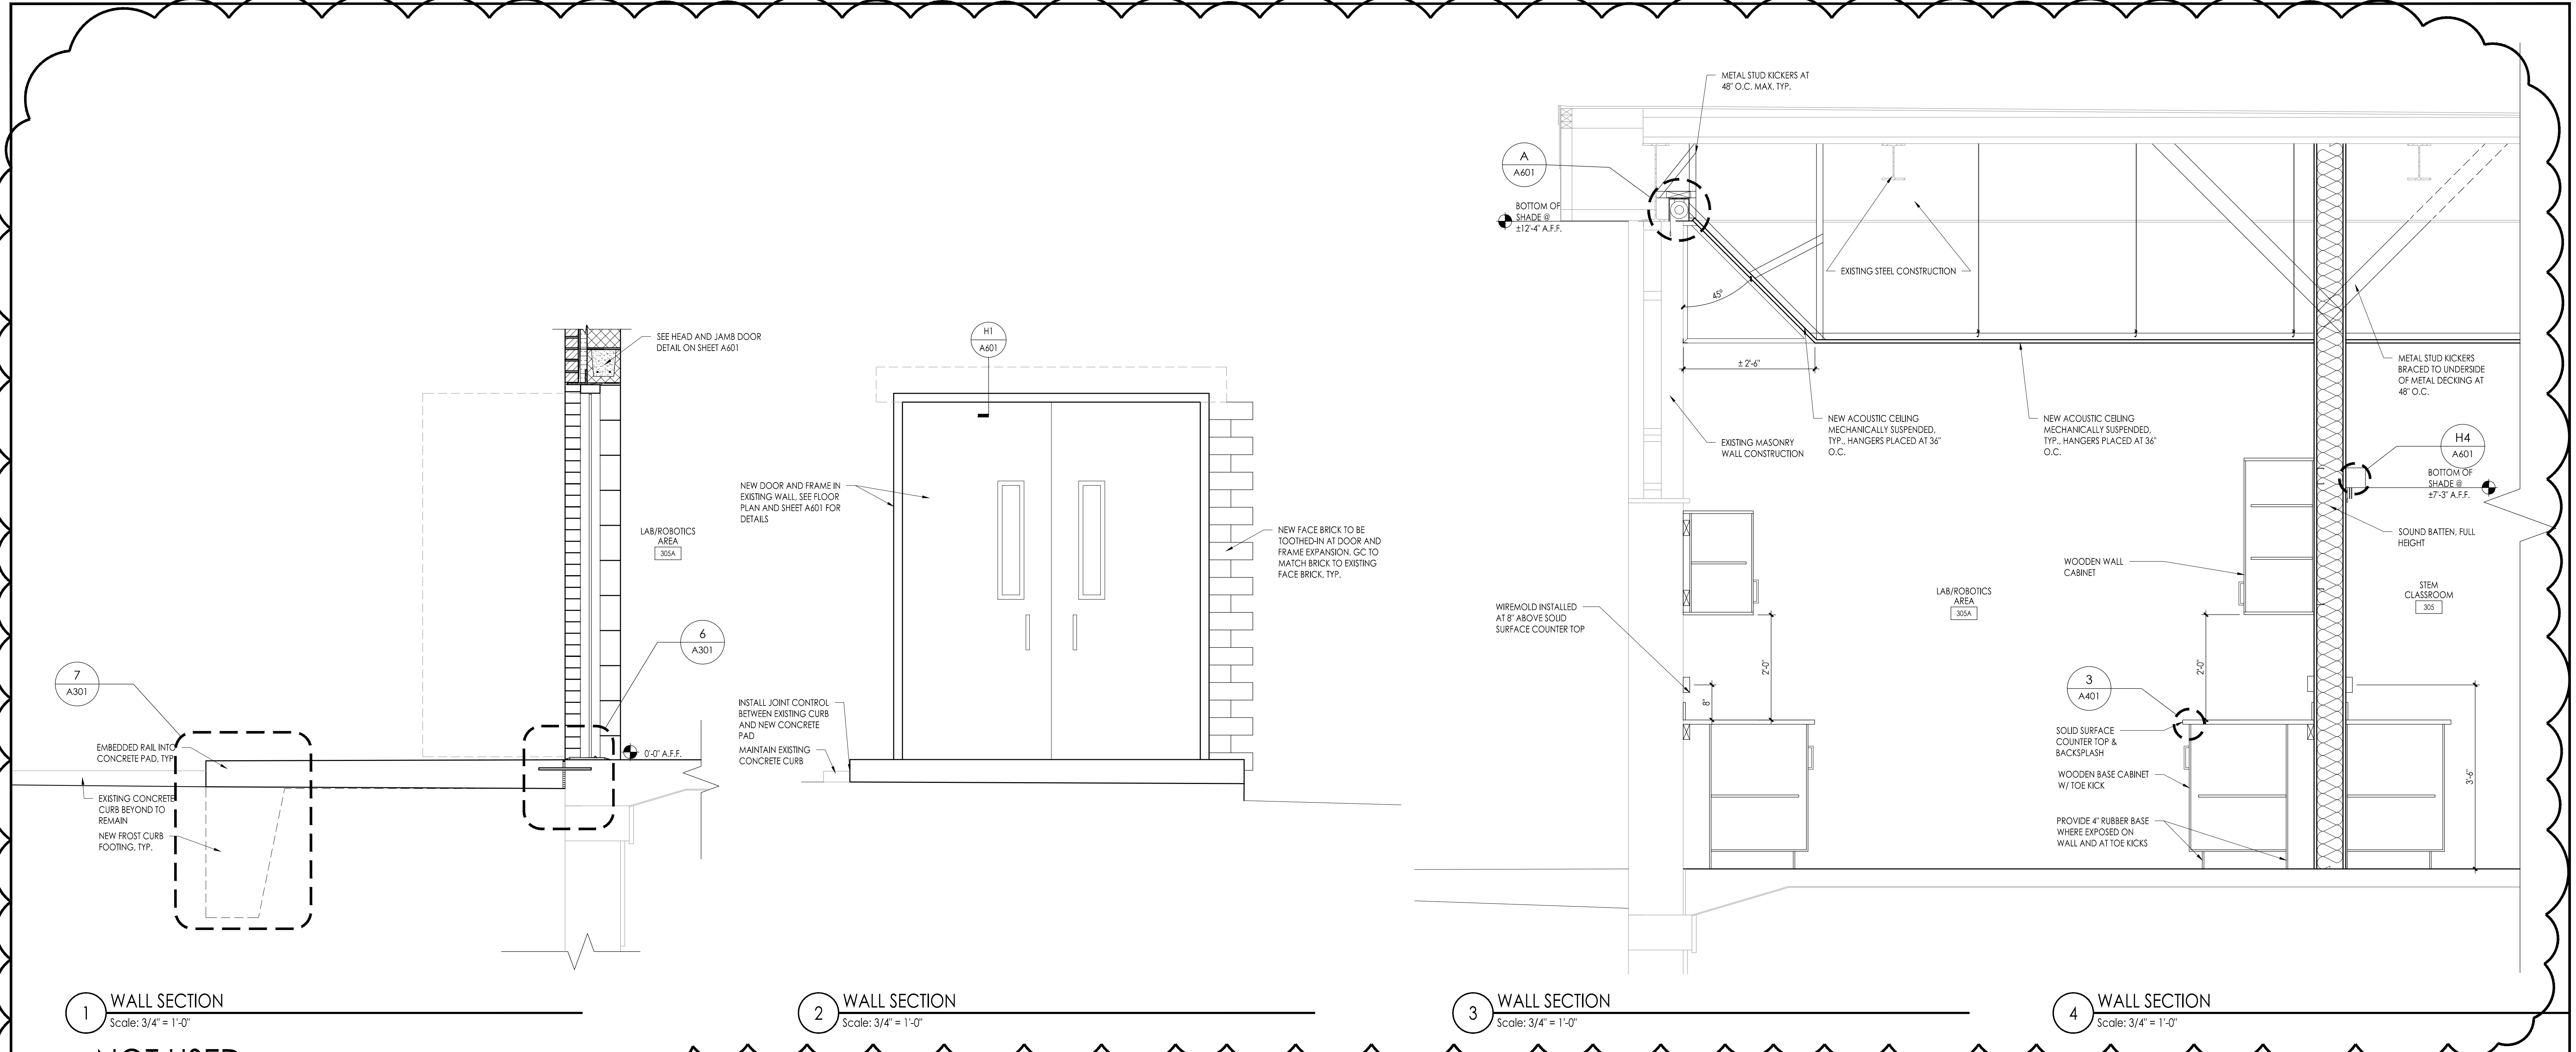

1 WALL SECTION
Scale: 3/4" = 1'-0"


2 WALL SECTION
Scale: 3/4" = 1'-0"

3 WALL SECTION
Scale: 3/4" = 1'-0"


4 WALL SECTION
Scale: 3/4" = 1'-0"

NOT USED


5 WALL SECTION
Scale: 3/4" = 1'-0"

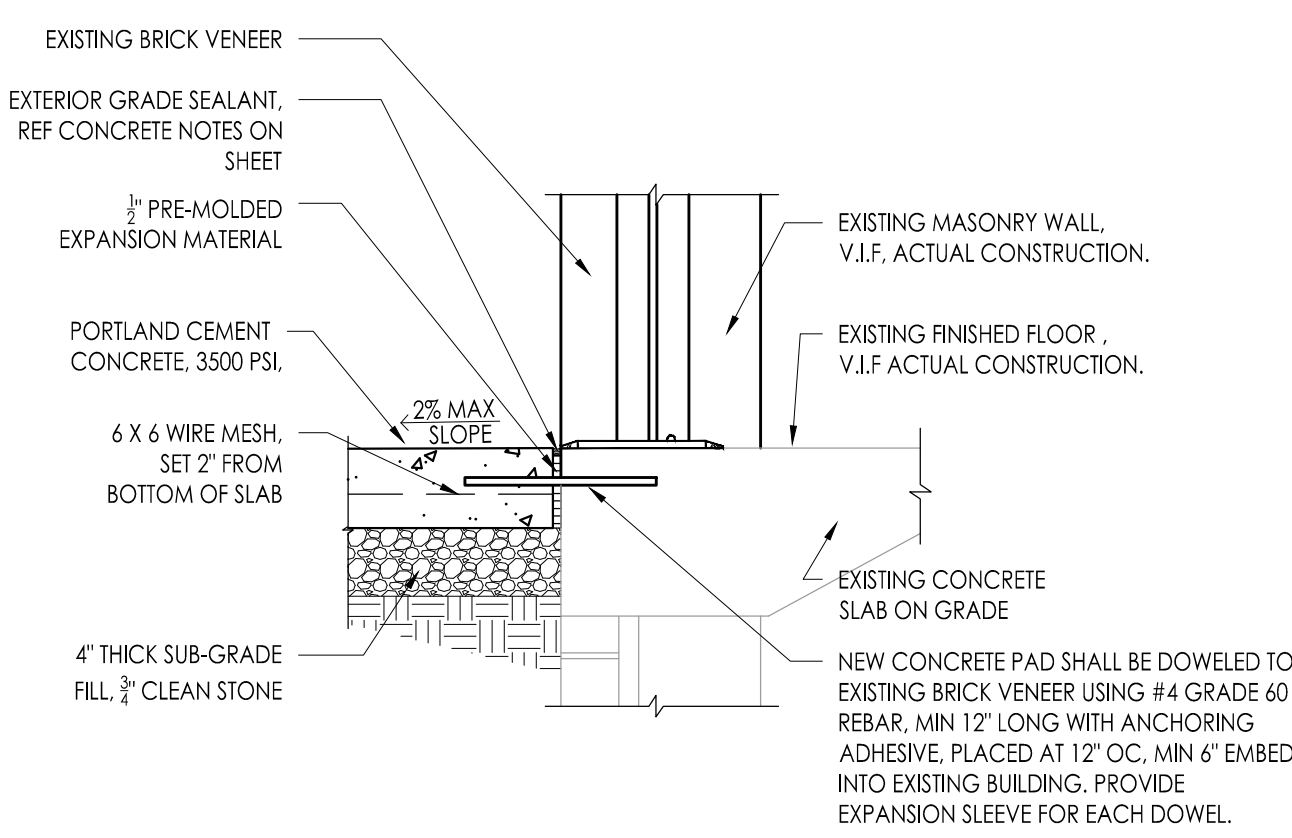

6 CONCRETE PAD TIE-IN TO EXISTING
Scale: 1" = 1'-0"

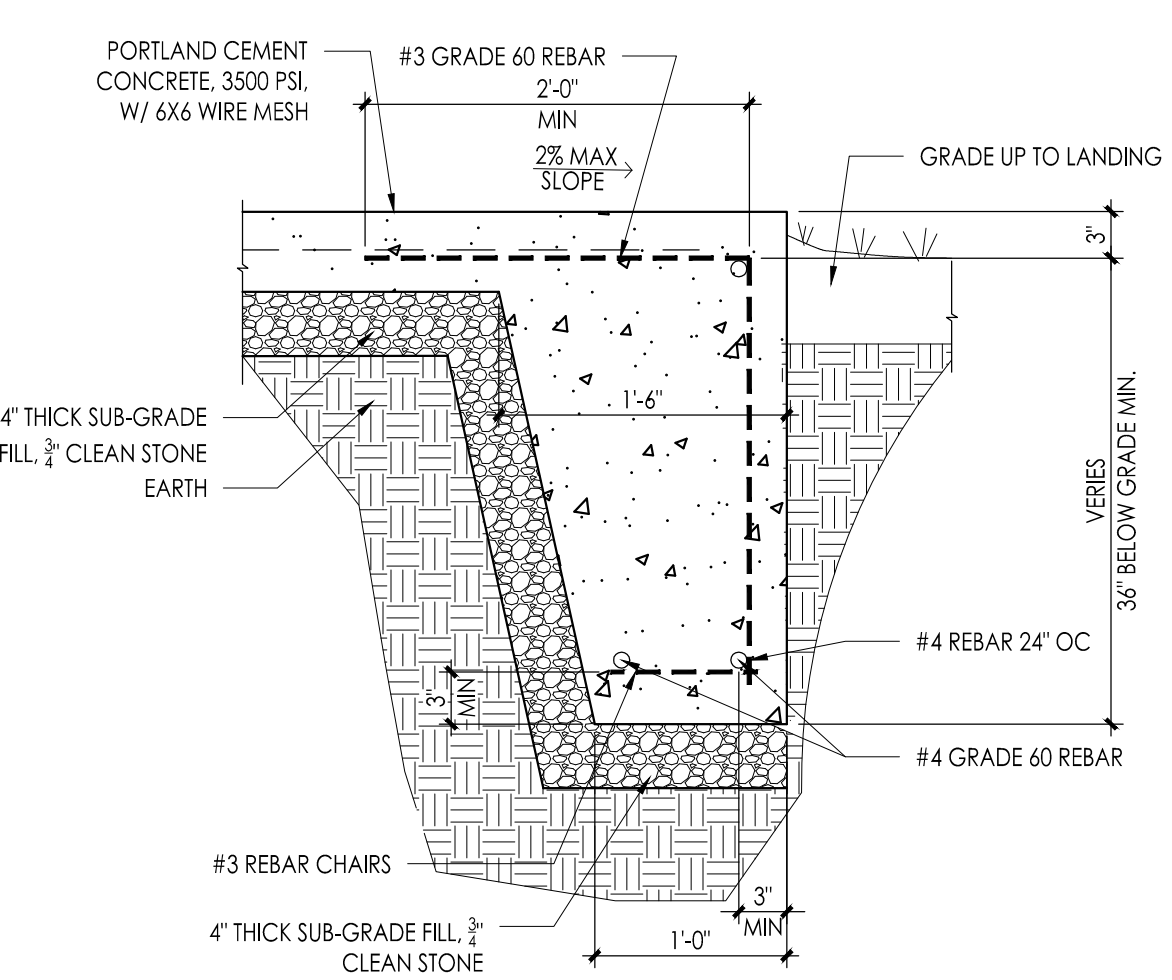


7 TURNDOWN CONCRETE PAD
Scale: 1" = 1'-0"

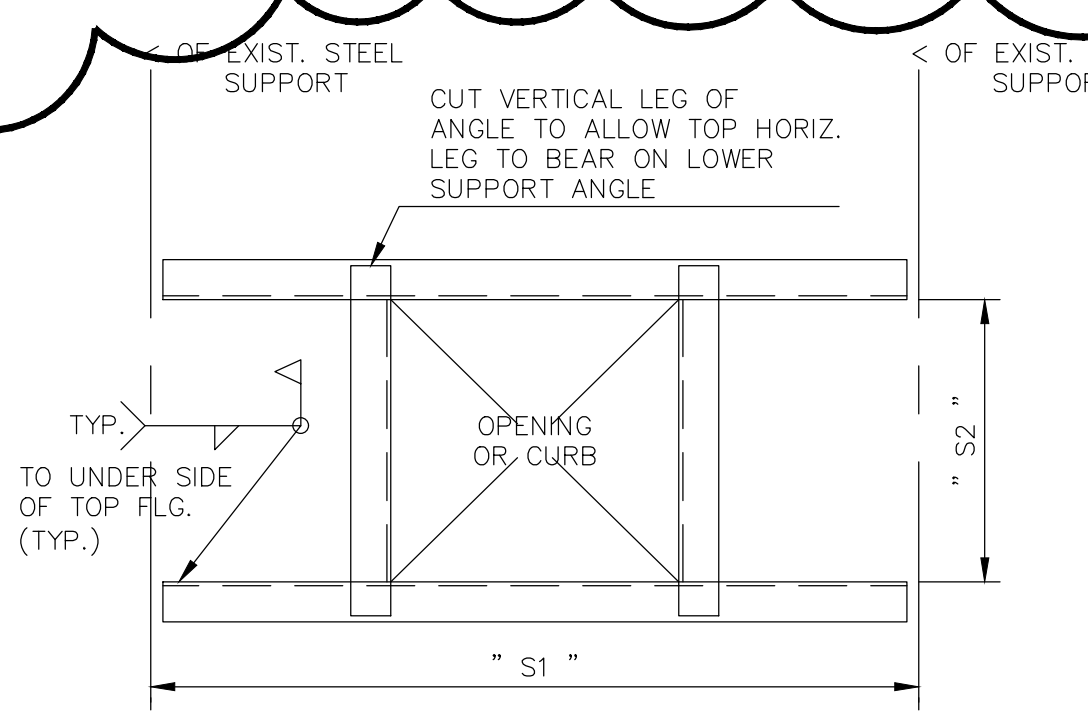

NOTES:
1. CONTRACTOR SHALL VERIFY ALL OPENINGS AND EXACT LOCATIONS OF OPENINGS PRIOR TO FABRICATION & ERECTION.
2. PROVIDE NEW STEEL ANGLES ON ALL SIDES OF MECH'L CURBS UNLESS EXISTING BEAM, JOIST OR ANGLE IS SHOWN ON PLAN.

NEW ANGLE SIZES TO BE:
FOR "S1" OR "S2" ≤ 6'-6" L-4"x4"x3/8"
FOR "S1" OR "S2" > 6'-6" L-6"x6"x3/8"

TYPICAL OPENING DETAIL AT ROOF UNDER NEW HVAC CURB
NOT TO SCALE

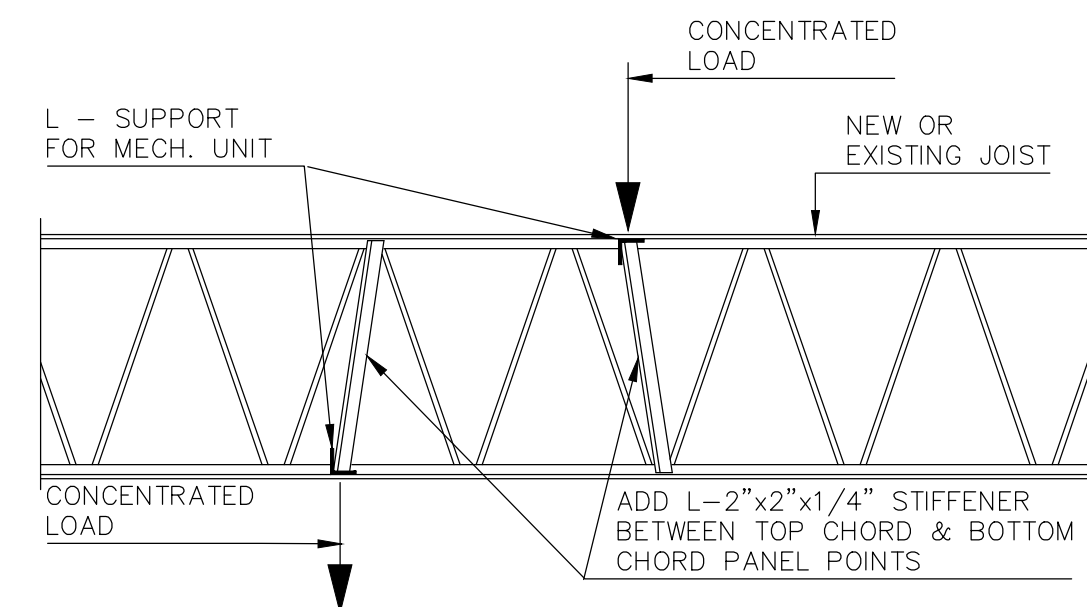

NOTE:
SUPPORTING LOAD AT CONDENSERS, MECHANICAL UNITS AND ALL CONCENTRATED LOADS GREATER THAN 300 lbs. OMIT IF LOAD IS WITHIN 3" OF A PANEL POINT.

TYPICAL DETAIL AT REINFORCED JOIST
NOT TO SCALE

NOTES:
UNLESS OTHERWISE SPECIFIED ON DRAWINGS PROVIDE & INSTALL LINTELS FOR ALL SQUARE HEAD MASONRY OPENINGS IN ALL MASONRY WALLS IN ACCORDANCE WITH THE FOLLOWING SCHEDULES & COMMENTS.

LOOSE LINTEL SCHEDULE		
[FOR 4", 8", 12" & 16" WALLS]		
MASONRY OPENING	LINTEL SIZE	REMARKS
UP TO 4'-0"	L-3 1/2" x 3 1/2" x 1/4"	
4'-1" TO 6'-0"	L-5" x 3 1/2" x 5/16"	
6'-1" TO 8'-0"	L-6" x 3 1/2" x 5/16"	
OVER 8'-0"	W 8 x 18 +>	

LOOSE LINTEL SCHEDULE		
[FOR 6" WALLS]		
MASONRY OPENING	LINTEL SIZE	REMARKS
2'-0" TO 4'-0"	WT 7 x 11	
4'-1" TO 8'-0"	WT 8 x 13	

NOTES:
1. PROVIDE ONE (1) ANGLE FOR EACH 4" OF MASONRY WIDTH.
2. BEAR LINTELS 6" MINIMUM EACH SIDE OF OPENING.
3. ALL LINTELS IN EXTERIOR WALLS TO BE GALVANIZED.
4. WHERE OPENINGS LOCATED NEXT TO COLUMNS OR BEAMS, ATTACH TO STRUCTURAL STEEL CONNECTION NOT TO PROTRUDE INTO OPENING.
5. CONSULT ARCHITECTURAL, MECHANICAL & ELECTRICAL DRAWINGS FOR OPENING SIZE & LOCATION.

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02/11/22
Date

F V H D P C . C O M

Project Name
STEM Lab Alterations & Renovations at Clearview Regional Middle School

Project Owner Name
Clearview Regional High School District

Project Location
595 Jefferson Rd, Mullica Hill, NJ 08062

Project Number
5162C

Project Date
10/11/2023

Checked By
GRD

Drawn By
SB

Scale
AS NOTED

Drawing Name
WALL SECTIONS AND MISCELLANEOUS DETAILS

Revisions		
No.	Date	Description
1	10.20.23	ADDENDUM 1


Drawing Number
A301

GENERAL CASEWORK NOTES:

- CATALOG NUMBERS REFER TO MOST CURRENT CAMPBELL RHEA CASEWORK CATALOG UNLESS OTHERWISE NOTED. FOR REFERENCE ONLY.
- ALL CASEWORK DOORS AND DRAWERS TO HAVE LOCKS KEYS ALIKE PER ROOM AND MASTER KEY.
- ALL TOPS SHALL HAVE PLYWOOD AND SOLID SURFACE COVERING ON ALL EXPOSED SURFACES (UNLESS NOTED OTHERWISE). SEE EDGE DETAILS ON SHEET FOR SPECIFIC THICKNESS.
- ALL BACKSPASHES SHALL BE 1/2" SOLID SURFACES (UNLESS NOTED OTHERWISE).
- ALL FURNITURE AND EQUIPMENT SHOWN DOTTED AND/OR INDICATED AS (N.I.C.) & NOT IN CONTRACT.
- THE CASEWORK & EQUIPMENT SUB-CONTRACTOR(S) SHALL TURN OVER TO THE PLUMBING AND ELECTRICAL GENERAL CONTRACTOR IN A PACKAGE, ALL SINKS, FIXTURES, FAUCETS, TAILPIECES, STRAINERS, GAS COCKS, ETC., AND ELECTRICAL DEVICES, NIPPLES AND LOCKNUTS, ETC., FOR INSTALLATION AND FINAL CONNECTION.
- THE CASEWORK AND EQUIPMENT SUB-CONTRACTOR SHALL PROVIDE AN ITEMIZED LIST AND A DESIGNATED SITE LOCATION FOR THE TRANSFER OF THE MATERIALS REFERENCED IN NOTE 6 TO THE PLUMBING AND ELECTRICAL PRIME CONTRACTORS. THE LIST SHALL HAVE A DESCRIPTION OF THE ITEMS AND QUANTITY ALONG WITH A SIGN-OFF LINE FOR THE PLUMBING AND ELECTRICAL PRIME CONTRACTORS. A COPY OF THE SIGNED LIST IS TO BE SUBMITTED TO THE ARCHITECT / OWNER PRIOR TO BILLING FOR THIS EQUIPMENT.
- EQUIPMENT SUB-CONTRACTOR SHALL MAKE SINK CUT-OUTS.
- ALL OUTLETS WITHIN 2' OF A WATER SOURCE SHALL BE G.F.C.I. UNLESS NOTED OTHERWISE.
- SINK CABINETS SHALL BE INSTALLED BEFORE THE INSTALLATION OF ADJACENT CABINETS.
- ALL CONTRACTORS TO FIELD VERIFY ALL EXISTING CONDITIONS PRIOR TO CONSTRUCTION AND NOTIFY ARCHITECT IN WRITTEN FORM OF ANY DISCREPANCIES.
- PROVIDE ALL FILLERS AS REQUIRED. FILLERS AT BASE CABINETS SHALL BE AT FRONT OF CABINET AND COUNTERTOP SHALL BE CONTINUOUS OVER FILLER PANEL. FILLERS AT TALL CABINETS SHALL BE AT FRONT AND TOP OF CABINET. FILLERS AT WALL CASES SHALL BE AT FRONT, TOP AND BOTTOM OF CABINET. FINISH TO MATCH CASEWORK.
- ALL PRINTERS AND COMPUTERS ARE N.I.C. (TYPICAL)
- RUBBER BASE ON ALL CASEWORK BY G.C. (TYPICAL)
- ALL SCHEDULED EQUIPMENT MANUFACTURERS ARE "BASIS OF DESIGN" OR APPROVED EQUAL.

NOTE:
ALL FURNITURE AND EQUIPMENT WITHOUT THE SYMBOL OR MARKED (N.I.C.) IS NOT IN CONTRACT UNLESS NOTED OTHERWISE. SEE EQUIPMENT SCHEDULE FOR EQUIPMENT MARKED WITH THE SYMBOL.


NOTE:
PROVIDE A MINIMUM 18" BARRIER-FREE MANEUVERING CLEARANCE AT THE FULL SIDE OF ALL DOORS ADJACENT TO CABINETS, SHELVING, COUNTERS, BACKSPLASH, ETC.

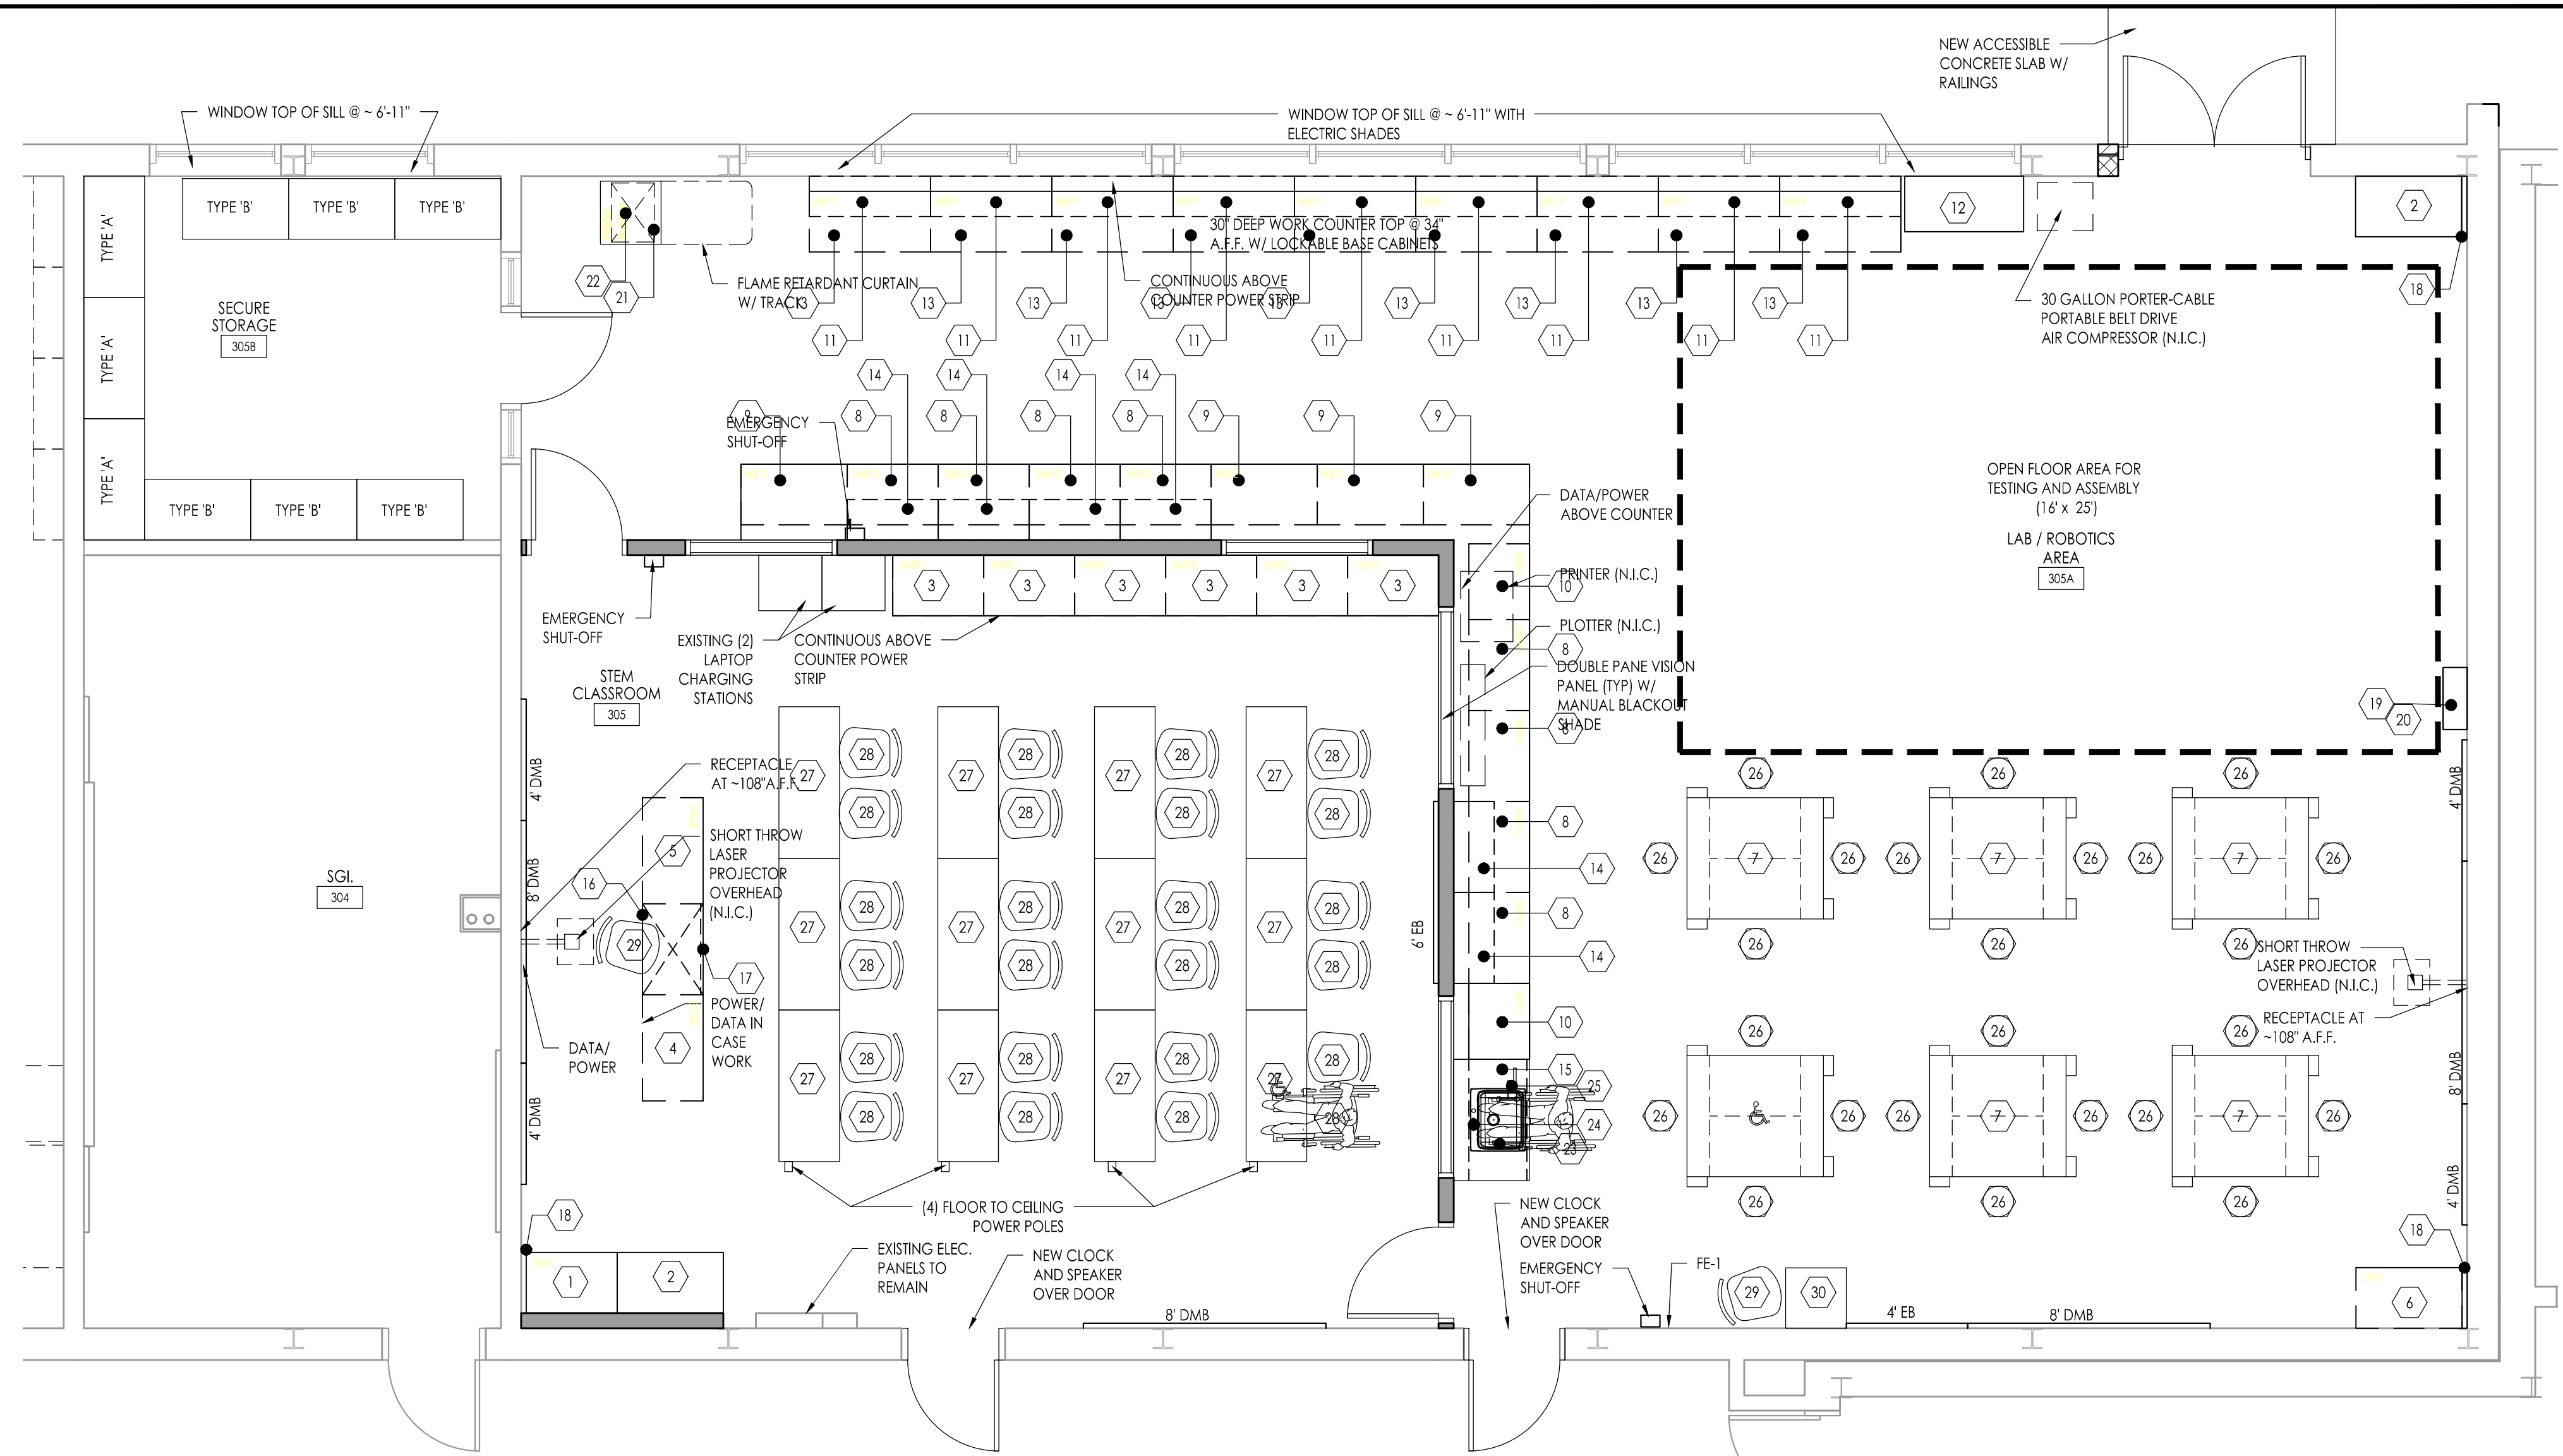

EQUIPMENT SCHEDULE


ITEM NO.	MANUFACTURER	CAT. NO.	DESCRIPTION	WIDTH	DEPTH	HEIGHT	REMARKS
1	CAMPBELL RHEA (OR APPROVED EQUAL)	5866	WARDROBE AND STORAGE CASE	35-1/4"	22-1/2"	84"	(1) FIXED SHELF; (3) ADJUSTABLE SHELVES; (1) HANGER ROD; 3 POINT LATCHING HANDLE, WARDROBE ON LEFT.
2	CAMPBELL RHEA (OR APPROVED EQUAL)	5690	TALL STORAGE CABINET	41-1/4"	22-1/2"	84"	(1) FIXED CENTER SHELF; (4) ADJUSTABLE SHELVES; ANCHOR TO WALL
3	CAMPBELL RHEA (OR APPROVED EQUAL)	3480C	OPEN BASE CABINET	35-1/4"	22-1/2"	33"	(2) ADJUSTABLE SHELVES
4	CAMPBELL RHEA (OR APPROVED EQUAL)	3755E	BASE CABINET	41-1/4"	22-1/2"	33"	DOUBLE DOORS: POWER / DATA IN BASE CABINET; W/ BASE PANEL
5	CAMPBELL RHEA (OR APPROVED EQUAL)	3703E	BASE CABINET	41-1/4"	22-1/2"	33"	(4) DRAWERS AND DOOR HINGED LEFT; W/ BASE PANEL
6	CAMPBELL RHEA (OR APPROVED EQUAL)	6960	WARDROBE AND SUPPLY CASE	41-1/4"	22-1/2"	84"	(1) HANGER; (1) FIXED HAT SHELF; (2) ADJ. SHELVES; (2) LARGE DRAWERS W/ FILE FOLLOWERS; (1) SHALLOW DRAWER W/ ADJ. PARTITIONS FOR RECORD CARDS UP TO 5"x8"; (1) 10"x12" MIRROR; PIN TRAY AND TOWEL BAR ON RIGHT HAND DOOR
7	CAMPBELL RHEA (OR APPROVED EQUAL)	7302	STUDENT WORK BENCH	54"	48"	31-1/4"	BASE CABINET HAS (12) INDIVIDUAL LOCKERS, MASTER KEYED. ASSEMBLY HAS (4) 7352-A WOODWORKING VISES WITH ALUMINUM HANDLES. TOP IS 2-1/4" LAMINATED HARD MAPLE.
8	CAMPBELL RHEA (OR APPROVED EQUAL)	3481D	BASE CABINET	35-1/4"	22-1/2"	33"	DOUBLE DOORS; (1) ADJ. SHELF
9	CAMPBELL RHEA (OR APPROVED EQUAL)	3481E	BASE CABINET	41-1/4"	22-1/2"	33"	DOUBLE DOORS; (1) ADJ. SHELF
10	CAMPBELL RHEA (OR APPROVED EQUAL)	3481C	BASE CABINET	30"	22-1/2"	33"	DOUBLE DOORS; (1) ADJ. SHELF
11	CAMPBELL RHEA (OR APPROVED EQUAL)	4710	WALL CABINET	47-1/4"	16"	23-3/4"	DOUBLE DOORS; (1) ADJ. SHELF
12	CAMPBELL RHEA (OR APPROVED EQUAL)	6779B	FLAMMABLE STORAGE CABINET	47"	22"	35"	34-GAL. CAPACITY METAL CAB. W/ (1) ADJ. SHELF; SWINGING DOORS OPEN TO 180°; DOORS HAVE THREE-POINT LATCHING SYSTEM W/ BUILT-IN LOCK.
13	CAMPBELL RHEA (OR APPROVED EQUAL)	3481F	BASE CABINET	47-1/4"	22-1/2"	33"	DOUBLE DOORS; (1) ADJ. SHELF
14	CAMPBELL RHEA (OR APPROVED EQUAL)	4730	WALL CABINET	35-1/4"	16"	31-1/4"	DOUBLE DOORS; (2) ADJ. SHELF
15	CAMPBELL RHEA (OR APPROVED EQUAL)	8760	ADA CLOSURE PANEL ASSEMBLY	48"	22-1/2"	33"	
16	CAMPBELL RHEA (OR APPROVED EQUAL)	7073B	KNEESPACE COMPONENTS	35-1/4"	22-1/2"	4-7/8"	3/2" SOLID LUMBER FRONT RAIL W/ 30" CLEARANCE AREA
17	CAMPBELL RHEA (OR APPROVED EQUAL)	CDC349B	BACK PANEL	36"	3/2"	30"	SOLID LUMBER TO MATCH REST OF CASEWORK
18	CAMPBELL RHEA (OR APPROVED EQUAL)	9084-152	FILLER	6"	-	84"	FIELD CUT
19	CAMPBELL RHEA (OR APPROVED EQUAL)	6784	SAFETY GOGGLES CABINET	24-1/2"	9-1/2"	32"	REINFORCED STEEL CABINET W/ BAKED WHITE ENAMEL FINISH & VANDAL RESISTANT LOCKING DOUBLE DOORS
20	CAMPBELL RHEA (OR APPROVED EQUAL)	6790	SAFETY GOGGLES	-	-	-	QUANTITY (36)
21	ICI SCIENTIFIC INC.	P967-04	FUME HOOD BASE CABINETS	24"	22"	32"	(1) ADJUSTABLE SHELF; FULL BACK FOR ADDED SUPPORT
22	BMC LABORATORY	8-810	SPRAY BOOTH	24"	22"	46-1/2"	SEE SPECIFICATION FOR ACCESSORIES I.E. EXHAUST BLOWER; EXPLOSION PROOF LIGHT FIXTURE; EXPLOSION PROOF RECEPTACLE; EXPLOSION PROOF SWITCH; EPOXY RESIN COUNTERTOP; FLAME RETARDANT CURTAIN W/ TRACK
23	ELKAY	LRADQ252260	LUSTERTONE CLASSIC STAINLESS STEEL	25"	22"	6"	SOUND DEADEN AT BOTTOM
24	JUST	J-1174-K3	FAUCET GROUP	8"	-	12-1/8"	4" VANDAL RESISTANT WRIST BLADES; 1.0 GPM AERATORS; ADA COMPLIANT
25	WATER SAVER	EW806	EYEWASH, DECK MOUNTED	-	-	-	RIGHT HAND MOUNTED; DUST COVER FOR EACH SPRAY HEAD; AP3600 THERMOSTATIC MIXING VALVE (TMV)
26	VIROCO (OR APPROVED EQUAL)	1211927FG	LAB STOOLS - 121 SERIES	17-7/8"	17-7/8"	VARIES	ADJ. HEIGHT STOOL; HARD PLASTIC SEAT W/ FELT-BASE GUIDES
27	VIROCO (OR APPROVED EQUAL)	FT2460	FLIP-TOP TECHNOLOGY TABLES	60"	24"	34"	ADJ. HEIGHT; 18" DEEP WORK SURFACE W/ 6" DEEP FLIP-TOP COMPARTMENT FOR WIRE MANAGEMENT
28	VIROCO (OR APPROVED EQUAL)	ZU418-FG-BR	ZUMBA® SERIES - STUDENT CHAIRS	20-3/4"	20-5/8"	32-1/4"	18" SEAT-HEIGHT; PROVIDE W/ FELT-BASE GUIDES AND BOOKRACK
29	VIROCO (OR APPROVED EQUAL)	4301	TASK CHAIR - 4300 SERIES	19-3/4"	18-1/2"	VARIES	ADJ. SEAT HEIGHT
30	VIROCO (OR APPROVED EQUAL)	IKM12	INSTRUCTOR MEDIA TOWER	27"	30"	40-5/8"	PROVIDE W/ LECTERN TOP (M/T); AND CASTERS
31	VIROCO (OR APPROVED EQUAL)	17A2ELECT	POWER STRIP - PLATEAU® SERIES	-	-	-	12' CORD POWER STRIP W/ DIAGNOSTIC LEDS; W/ 7 OUTLETS & EXCEEDS IEEE 587 CATEGORY A+B SURGE SUPPRESSION SPECIFICATIONS. PROVIDE (1) FOR EACH DESK; TOTAL OF (12)

ENLARGED ROOM LAYOUT
1/4" = 1'-0"

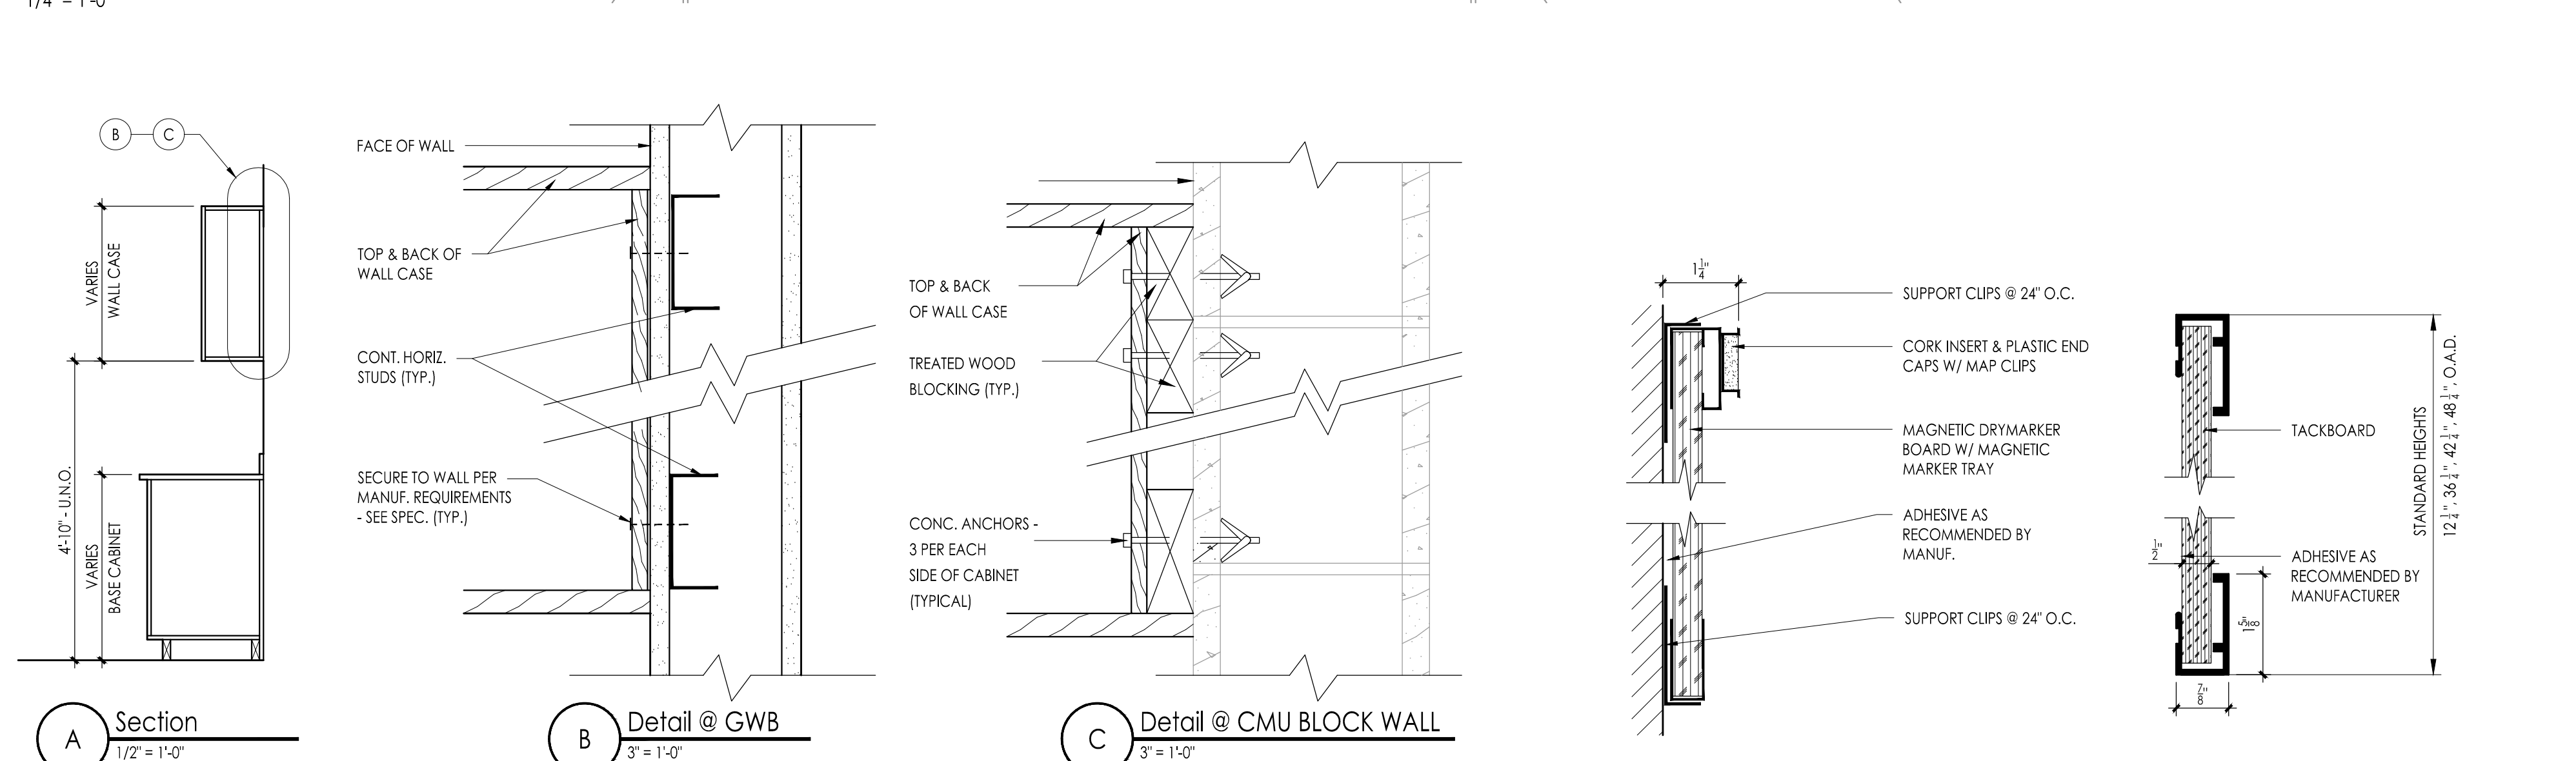


CABINET WALL MOUNT DETAILS
Scale: VARIES

1 MARKER/EXHIBITION BOARD DETAILS
Scale: 6\"/>

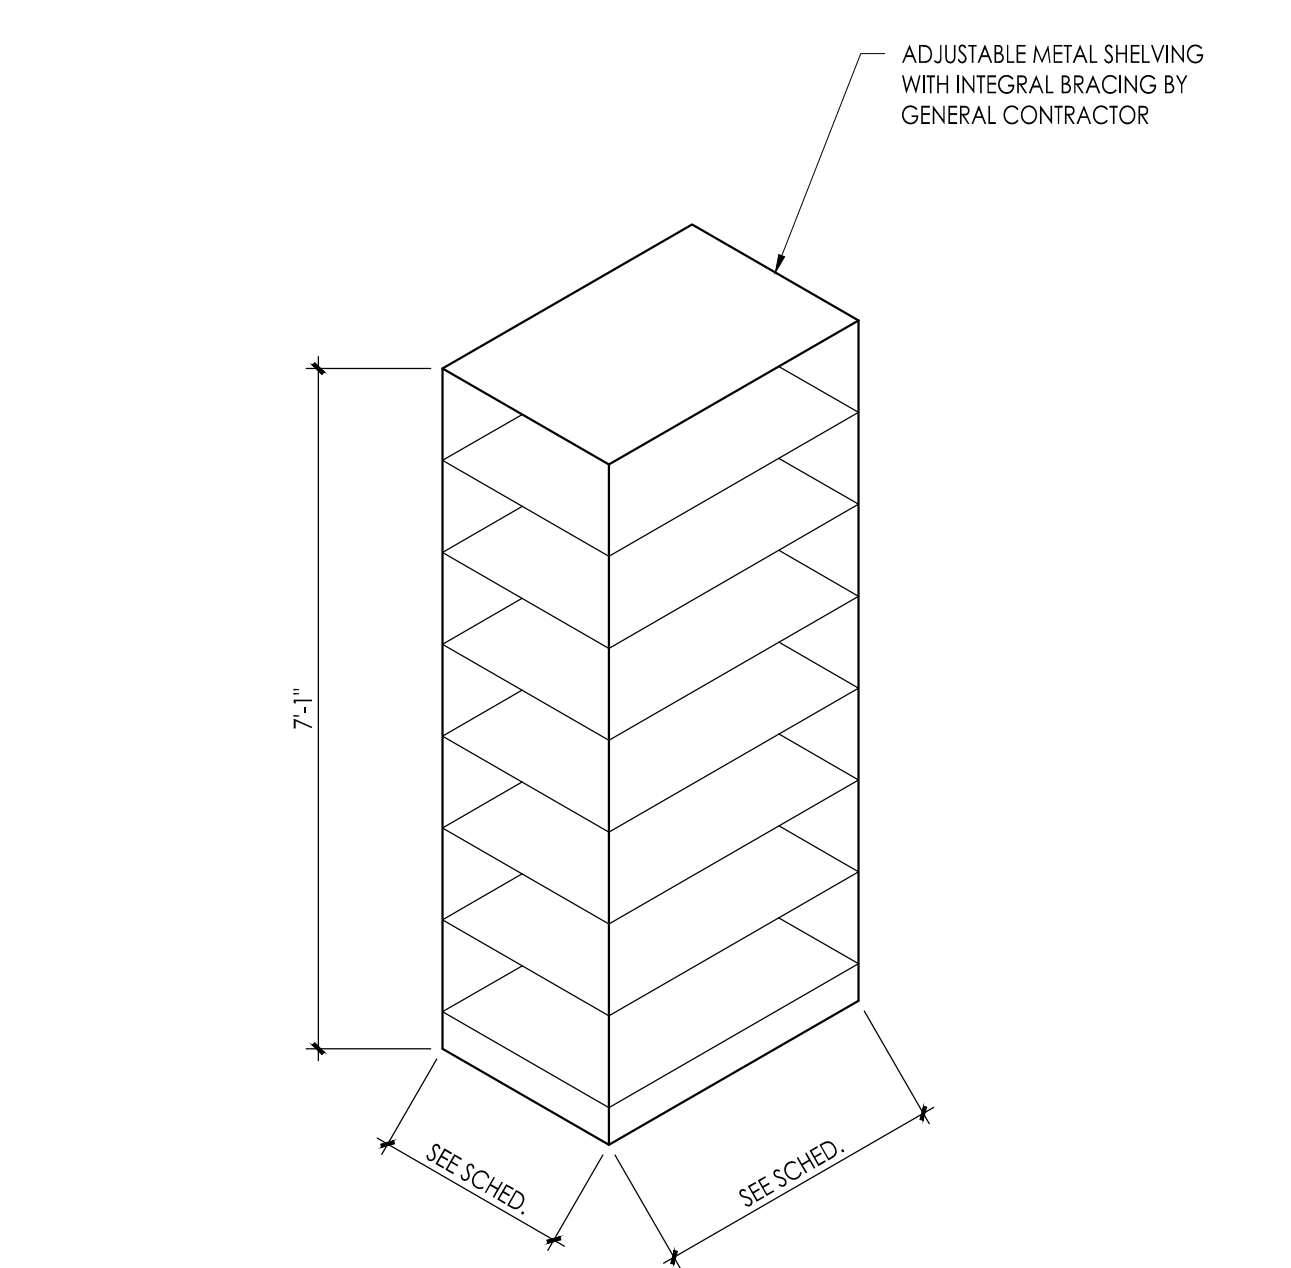


METAL SHELVING BY GENERAL CONTRACTOR

TYPE	W	D	H	TYPE	REMARKS
A	48"	24"	7'-1"	A	4 ADJ SHELVES 1 FIXED (SPACED AT 18")
B	42"	24"	7'-1"	A	4 ADJ SHELVES 1 FIXED (SPACED AT 18")

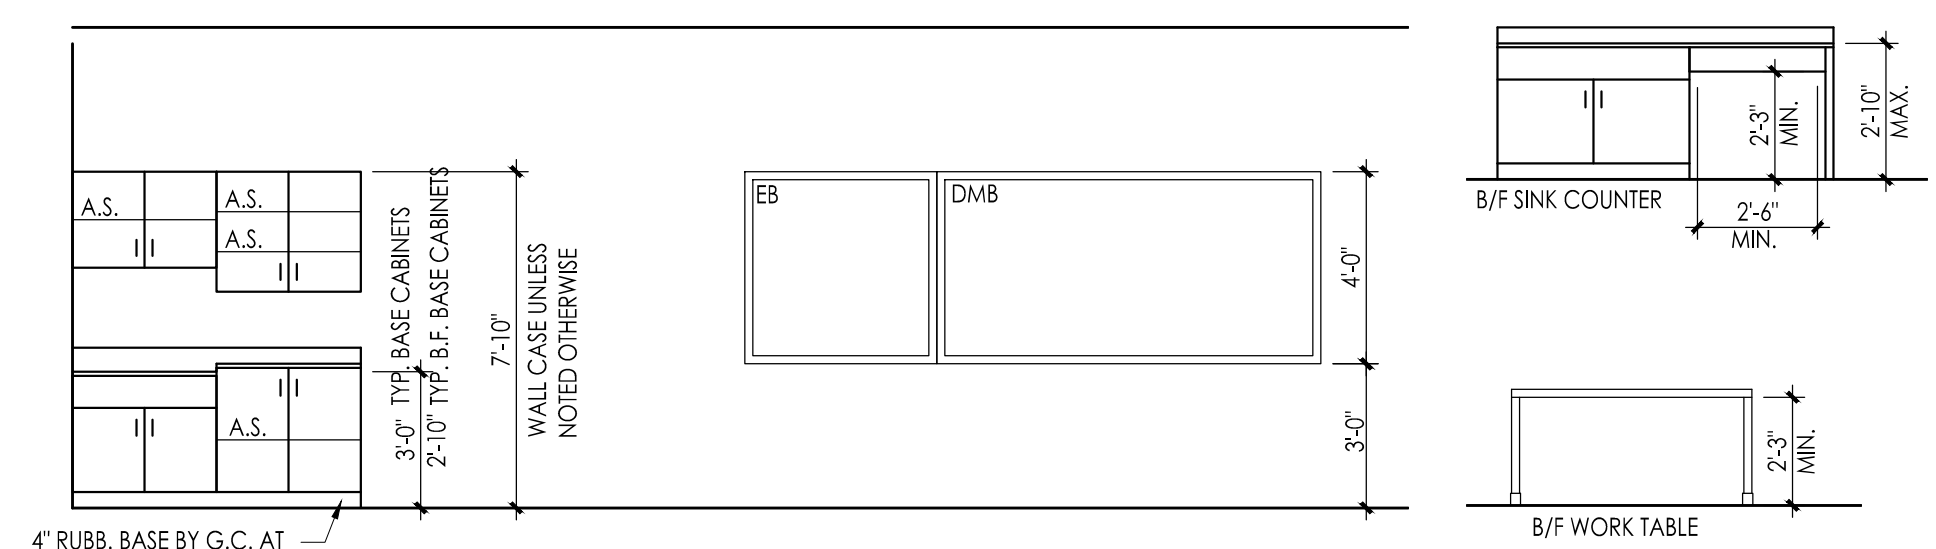

2 MOUNTING HEIGHT DETAILS
Scale: 1/4" = 1'-0"

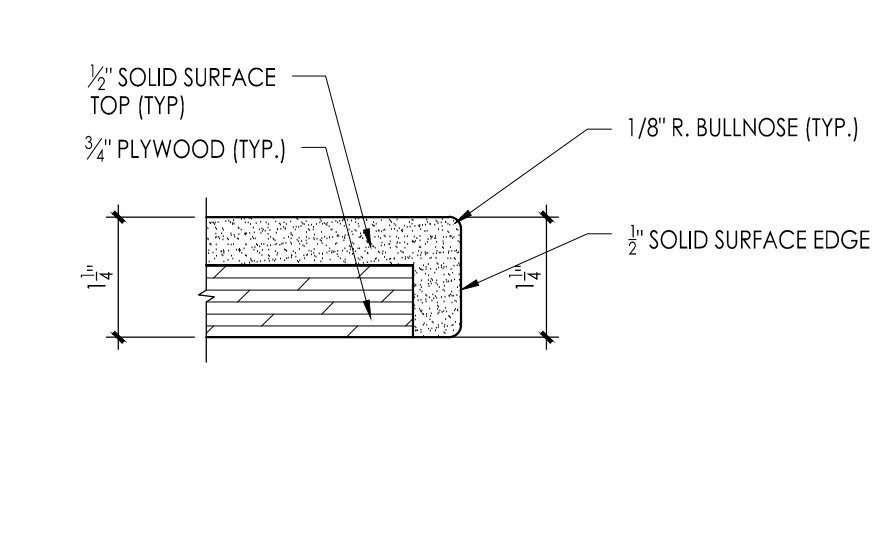

3 SOLID SURFACE EDGE DETAIL
Scale: 6\"/>

4 METAL SHELVING TYPES
Scale: 1/2" = 1'-0"

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KM/SB

Scale
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Drawing Name
ENLARGED ROOM LAYOUT

Revisions

No.	Date	Description
1	10.20.23	ADDENDUM 1

Drawing Number
A401

DOOR AND FRAME SCHEDULE

DR NO	DOOR LOCATION	DOOR				FRAME				HARDWARE	RATING	SIGN TYPE	NOTES
		SIZE	TYPE	MATL	GLAZING	TYPE	MATL	HEAD	JAMB				
305	STEMCLASSROOM 305	3'-0" x 7'-0"	B	WD	FRIG-1	HM	HM	ETR	S2	5.0	20 MIN	9	SEE DOOR SCHEDULE NOTES 1, 6, 9, 10, 11
305.1	STEMCLASSROOM 305	3'-0" x 7'-0"	B	WD	FRIG-1	HM	HM	H3	J3	4.0	--	8	SEE DOOR SCHEDULE NOTES 6, 8, 9, 10
305.2	STEMCLASSROOM 305	3'-0" x 7'-0"	B	WD	TPG	H1	HM	H3	J3	3.0	--	3	SEE DOOR SCHEDULE NOTES 6, 8, 9, 10
305.3	STEMCLASSROOM 305	4'-8" x 3'-4"	--	--	TPG	B1	HM	H4	J4	S3	--	--	SEE DOOR SCHEDULE NOTES 3, 9
305.4	STEMCLASSROOM 305	4'-8" x 3'-4"	--	--	TPG	B1	HM	H4	J4	S3	--	--	SEE DOOR SCHEDULE NOTES 3, 9
305.5	STEMCLASSROOM 305	5'-8" x 3'-4"	--	--	TPG	B2	HM	H4	J4	S3	--	--	SEE DOOR SCHEDULE NOTES 3, 9
305.6	STEMCLASSROOM 305	5'-8" x 3'-4"	--	--	TPG	B2	HM	H4	J4	S3	--	--	SEE DOOR SCHEDULE NOTES 3, 9
305A	LAB / ROBOTICS AREA 305A	3'-0" x 7'-0"	B	WD	FRIG-1	HM	HM	H2	J2	5.0	20 MIN	9	SEE DOOR SCHEDULE NOTES 2, 4, 6, 9, 10, 11
305A.2	LAB / ROBOTICS AREA 305A	4'-0" x 7'-0"	C	FRP	AL	AL	H1	J1	S1	1.0	--	3	SEE DOOR SCHEDULE NOTES 5, 7, 11
305B	SECURE STORAGE 305B	3'-0" x 7'-0"	A	WD	TPG	ETR	HM	ETR	ETR	2.0	--	10	SEE DOOR SCHEDULE NOTE 1, 11

DOOR SCHEDULE ABBREVIATIONS


- AL - ALUMINUM
- EXIST - EXISTING TO REMAIN
- FRIG-1 - FIRE-RATED IMPACT-RESISTANT GLAZING-TYPE 1
- FRP - FIBERGLASS REINFORCED POLYESTER
- HM - HOLLOW METAL
- SG - SECURITY GLAZING
- ST - STEEL
- SWF - SECURITY WINDOW FILM
- TPG - TEMPERED PLATE GLASS
- WD - WOOD

GENERAL DOOR NOTES

- ALL NEW DOORS IN NEW FRAMES TO BE 1 1/2" THICK AND HAVE A 1" UNDERCUT.
- UNLESS NOTED OTHERWISE
- ALL WIRING FOR DOOR SECURITY TO BE CONCEALED IN NEW FRAMES
- ANY EXISTING FRAME TO REMAIN ARE TO BE PRIMED AND REPAINTED TO MATCH NEW FRAME COLOR. COLOR TO BE SELECTED BY ARCHITECT.
- ALL INTERIOR DOORS TO HAVE A METAL VISION TRIM KIT
- ALL DOORS TO HAVE KEYS TO OPERATE ON THE PULL SIDE

DOOR SCHEDULE NOTES

- NEW DOOR IN EXISTING FRAME. VERIFY DOOR SET IN FIELD
- KNOCKDOWN FRAME
- BORROWED LIGHT FRAME W/ DOUBLE PANE GLAZING
- VERIFY EXISTING WALL THICKNESS
- AUTOMATIC FLUSH BOLT W/ EXIT PANIC ON ACTIVE DOOR
- PROVIDE DOOR PERIMETER SOUND SEAL AND AUTOMATIC DOOR BOTTOM
- PROVIDE SOUND & WEATHERSTRIPPING AT PERIMETER
- INSTALL DOUBLE PANE GLAZING IN FRAME
- INSTALL WINDOW SHADES. SEE DRAWINGS AND SPECIFICATIONS FOR DETAILS
- PROVIDE DOOR STOP
- DOOR TO HAVE CLOSER

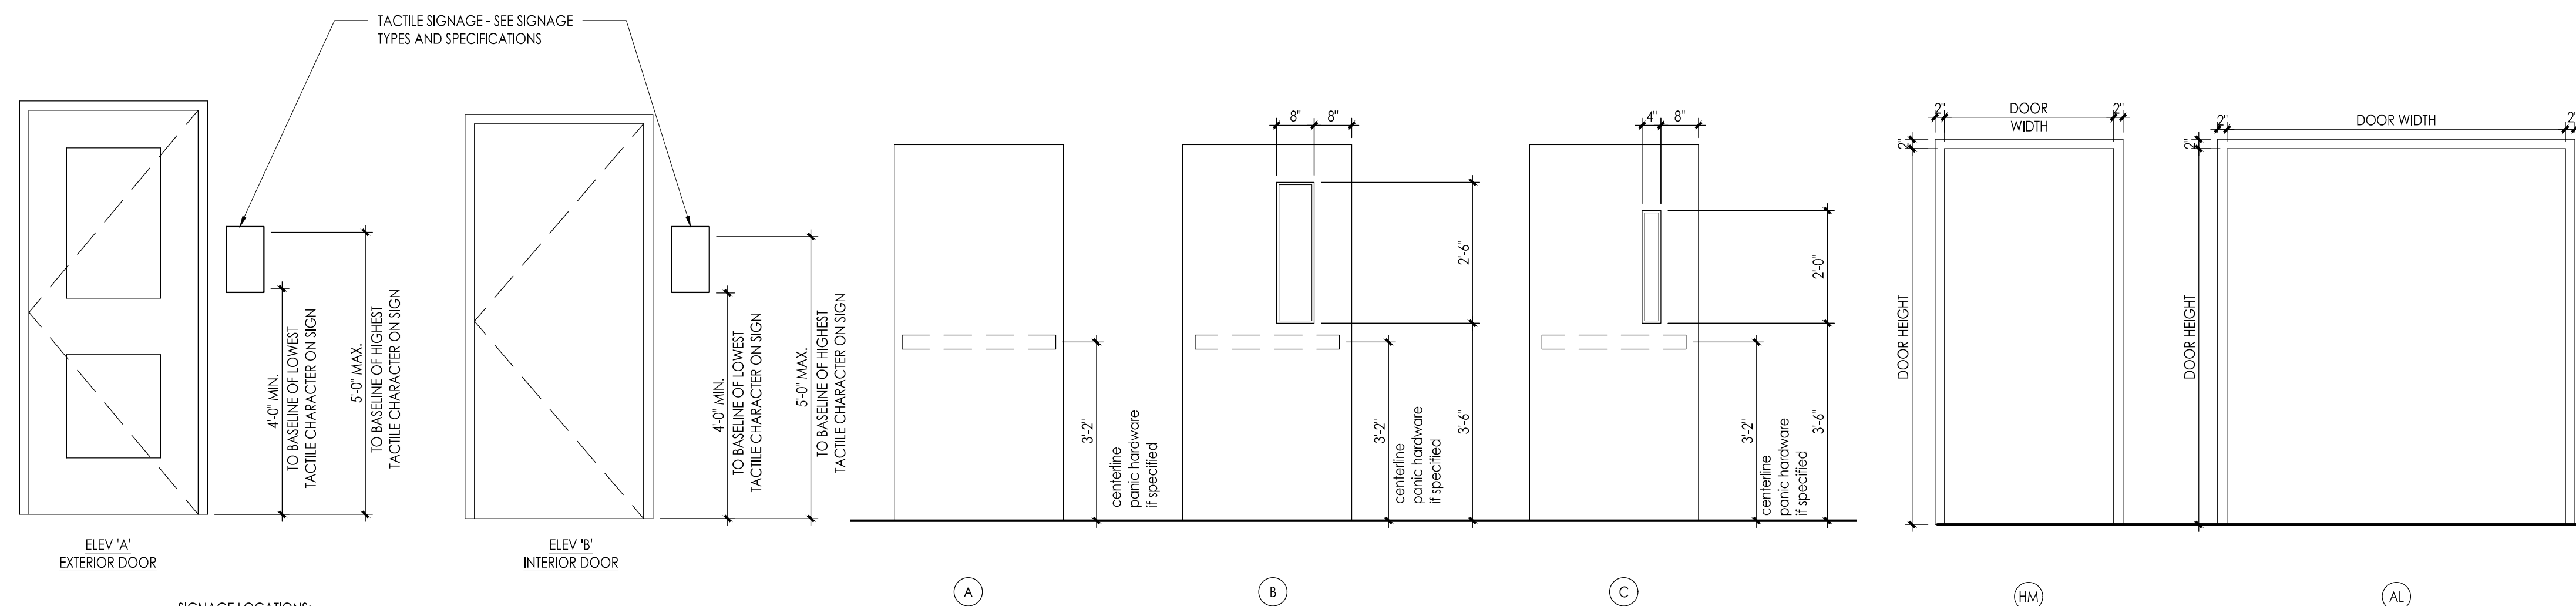

ROOM FINISH SCHEDULE

NUMBER	ROOM NAME	FLOOR	BASE		WAINSCOT		WALL FINISH		CEILING		NOTES
			MAT.	HT.	MAT.	HT.	MAT.	HT.	MAT.	HT.	
305	STEMCLASSROOM	SDT	RUB	4"	--	--	ETR-P / GP	ACB-1	10'-0"	SEE ROOM FINISH SCHEDULE NOTE 2	
305A	LAB / ROBOTICS AREA	SDT	RUB	4"	--	--	GP, GP	ACB-1	VARIABLE	SEE FINISH ROOM SCHEDULE NOTES 1 & 4	
305B	SECURE STORAGE	VCT	RUB	4"	--	--	ETR-P	ACB-1	ETR	SEE ROOM FINISH SCHEDULE NOTE 5	

ROOM FINISH SCHEDULE ABBREVIATIONS


- ACB-1 - ACOUSTIC CEILING BOARD TYPE 1 (2x4)
- A.F.F. - ABOVE FINISHED FLOOR
- B.F. - BARRIER FREE
- CP - CONCRETE MASONRY UNIT - PAINTED
- FRP - EXISTING TO REMAIN PAINT
- GP - GYPSUM BOARD - PAINT
- RUB - RUBBER BASE
- SDT - STATIC DISPERATIVE TILE
- VCT - VINYL COMPOSITION TILE

GENERAL ROOM FINISH NOTES

- SEE SPECIFICATIONS FOR ADDITIONAL INFORMATION ON MATERIALS / MANUFACTURER / PERFORMANCE AND WARRANTY INFORMATION.
- REFER TO MANUFACTURER'S INSTALLATION INSTRUCTIONS ON GROUNDING THE SDT FLOORING.
- WALLS ARE TO BE SOUND ATTENUATED FROM THE BOTTOM OF THE TRACKS TO THE BOTTOM OF THE STRUCTURAL DECK.
- GC TO PROVIDE SOUND SEALANT AT THE BOTTOM AND TOP OF METAL STUD TRACKS.
- ANY EXISTING RECEPACLES TO REMAIN. GC OR ELECTRIC SUBCONTRACTOR TO REPLACE FACE COVERS AND W/ NEW FACE BRICK TO MATCH EXISTING.

ROOM FINISH SCHEDULE NOTES

- WINDOW TREATMENT (WT-1) ELECTRICAL ROLLER SHADE SYSTEM AT EXTERIOR WINDOWS. SEE SPECIFICATION SECTION 1249.
- WINDOW TREATMENT (WT-2) MANUAL ROLLER SHADE SYSTEM AT CLASSROOM BORROWED LIGHTS. SEE SPECIFICATION SECTION 1249.
- REFERENCE EQUIPMENT SCHEDULE TO SEE EQUIPMENT THAT WILL BE PROVIDED BY OWNER AND INSTALLED BY GC.
- SEE REFERENCE EQUIPMENT SCHEDULE FOR DETAILS.
- NEW TILES IN EXISTING TO REMAIN. PAINT GRD AND LIGHT SUPPORT.

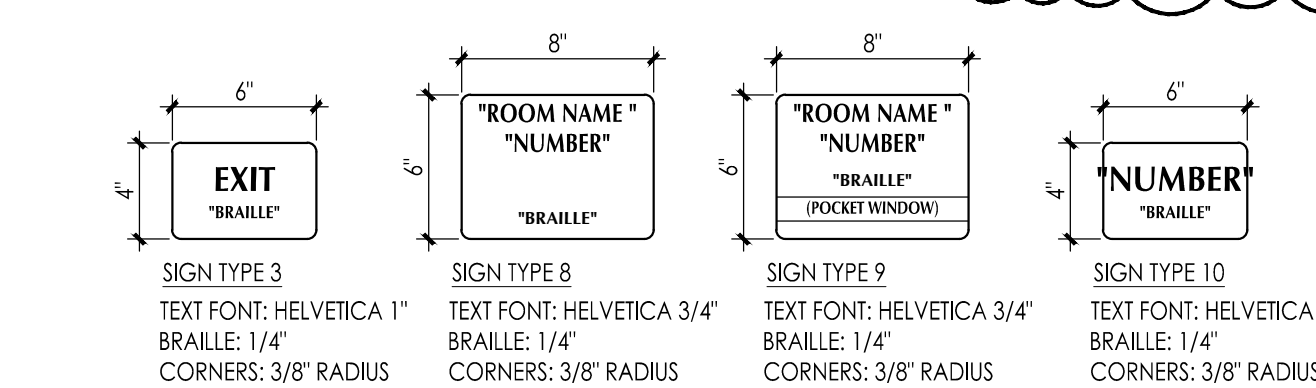


BORROWED LITE FRAME TYPES

SCALE: 1/2" = 1'-0"


DOOR SIGNAGE TYPES

SCALE: 1-1/2" = 1'-0"

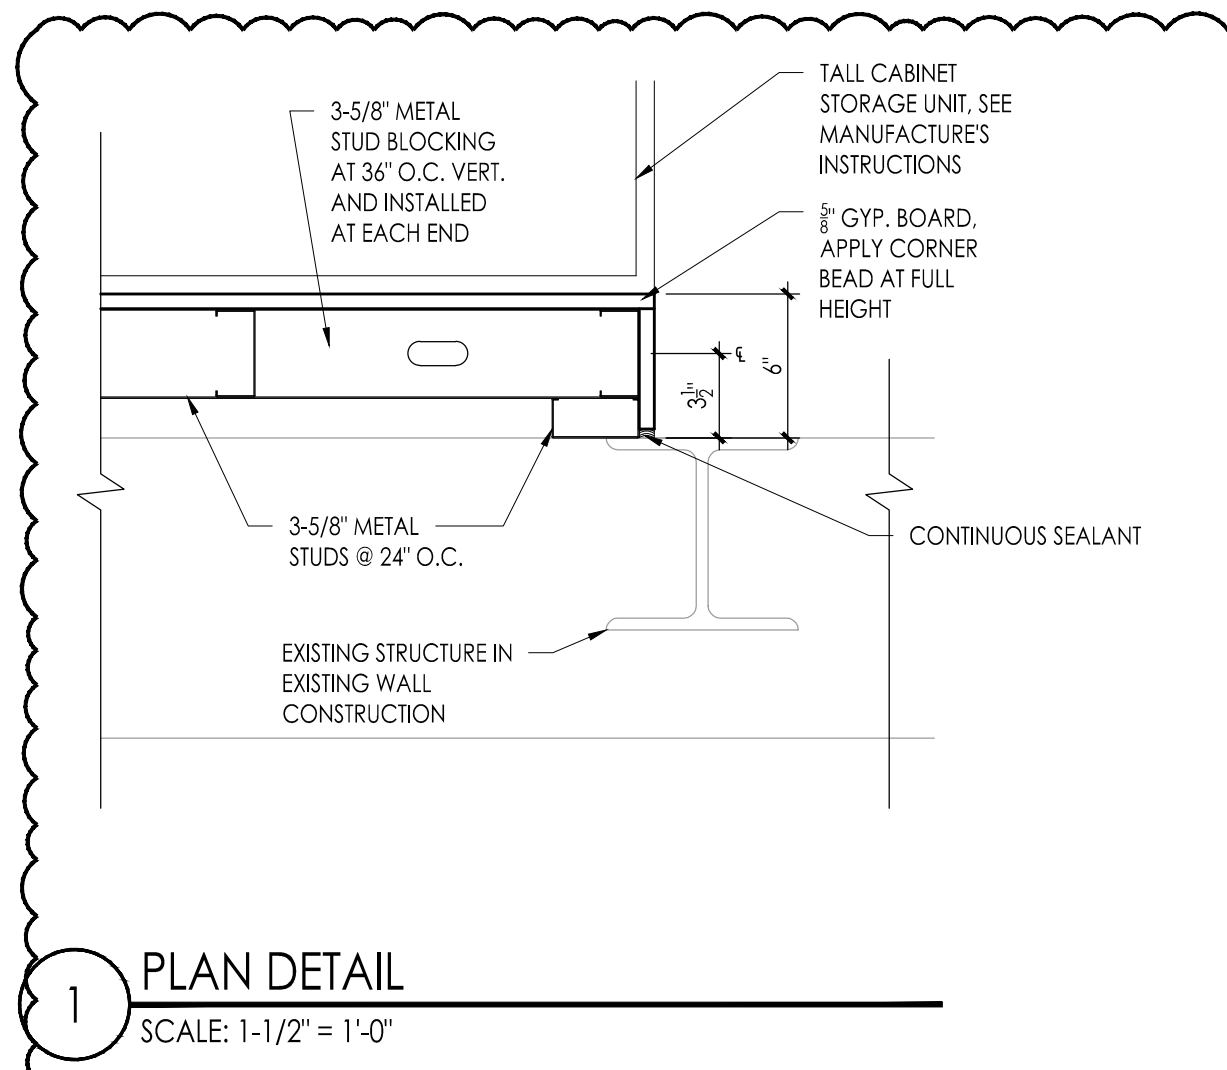

PLAN DETAIL

SCALE: 1-1/2" = 1'-0"

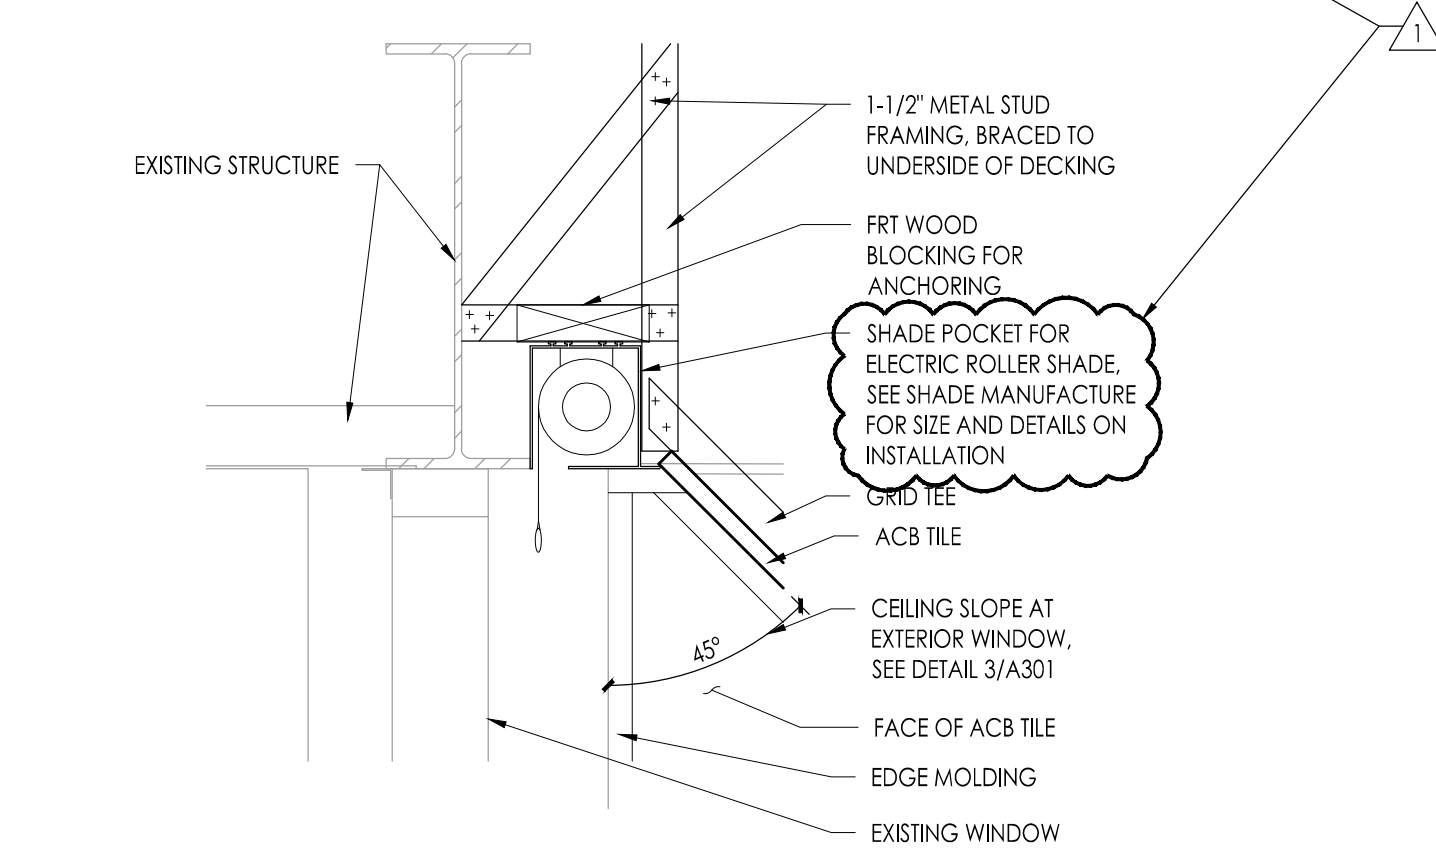

ELECTRIC ROLLER SHADE POCKET AT WINDOW


SCALE: 1-1/2" = 1'-0"

SIGN LOCATIONS

SCALE: 1/2" = 1'-0"

DOOR & FRAME TYPES

SCALE: 1/2" = 1'-0"

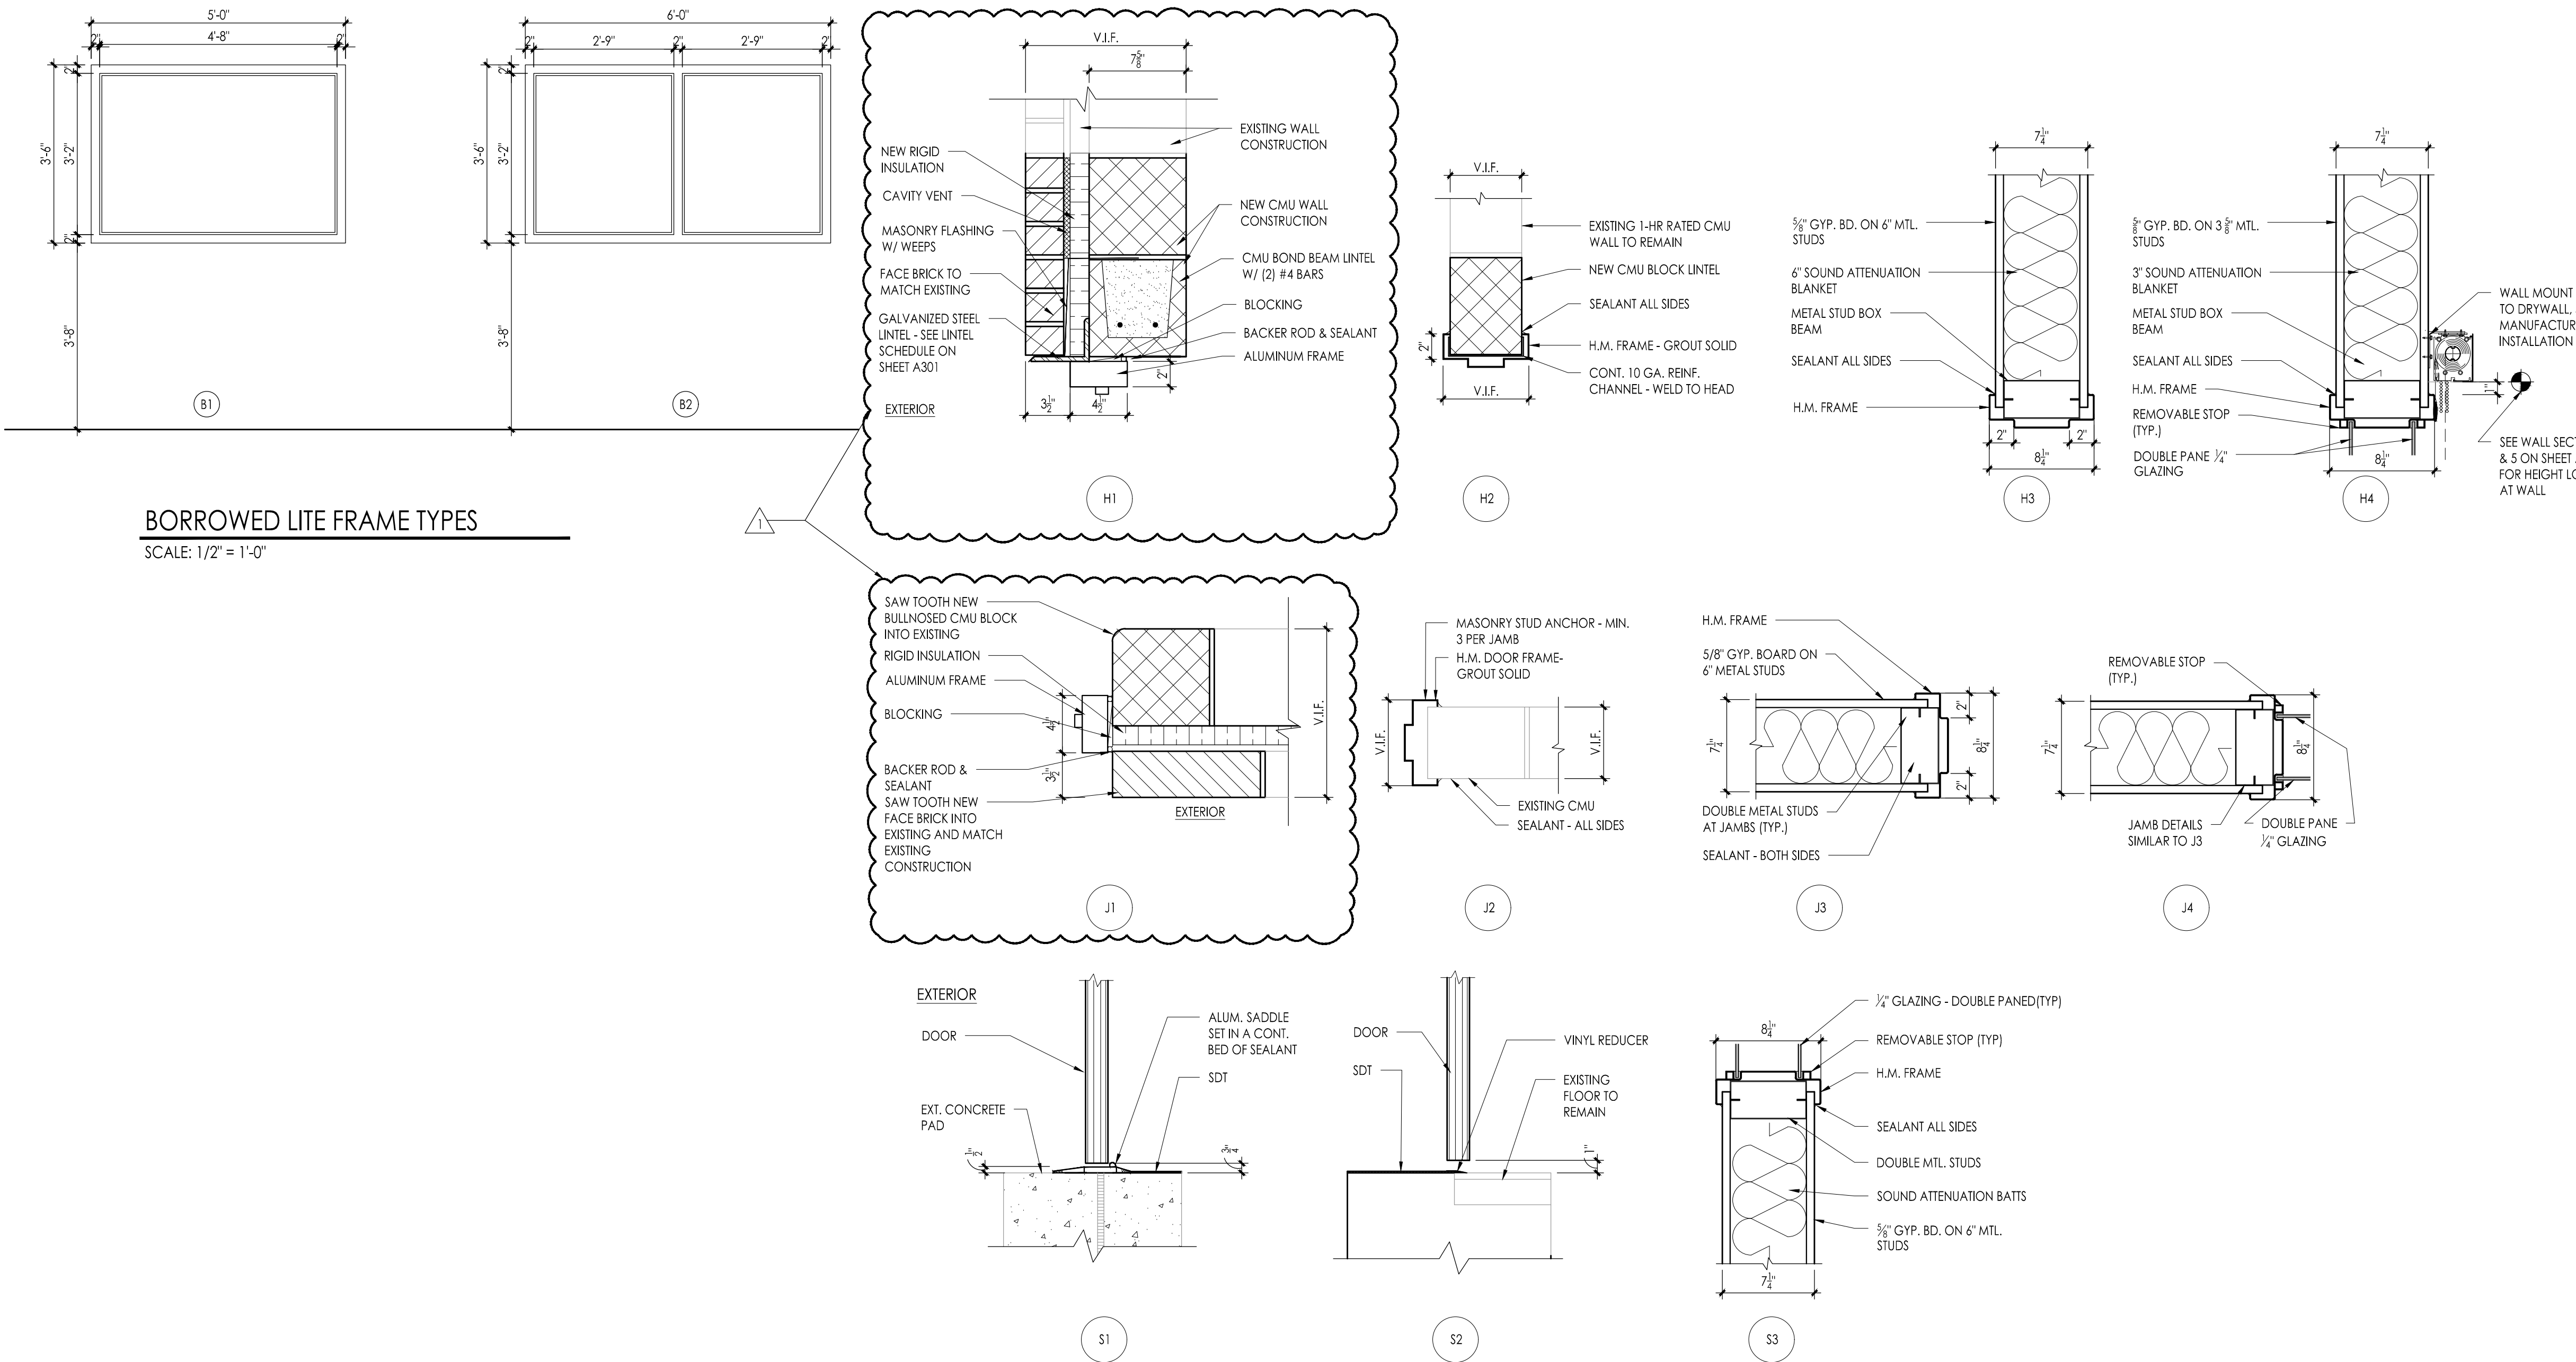

HEAD, JAMB, & SILL DETAILS

SCALE: 1-1/2" = 1'-0"

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Drawing Name
DOOR & FRAME DETAILS, SCHEDULES, NOTES AND PLAN DETAILS

Revisions

No.	Date	Description
Δ	10.20.23	ADDENDUM 1

Drawing Number
A601