ADDENDUM NO. 1

to

CONTRACT DOCUMENTS

for

STEM LAB ALTERATIONS AND RENOVATIONS AT CLEARVIEW REGIONAL MIDDLE SCHOOL

located at 595 Jefferson Road, Mullica Hill, NJ 08062

for the

CLEARVIEW REGIONAL HIGH SCHOOL DISTRICT

Mullica Hill, Gloucester County, New Jersey

Issued: October 20, 2023

FVHD PROJECT #5162C

FRAYTAK VEISZ HOPKINS DUTHIE, P.C.

Architects/Planners

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GILLAN & HARTMANN, INC.

Consulting Engineers

140 Whitaker Avenue, Suite 300 Mont Clare, PA 19453 M. Steven Gillan, P.E. License No. 24GE4470000

INTENT

This Document supersedes all conflicting and contrary information in said Contract Documents. Said documents are hereby amended in certain particulars as described herein after. Unless specifically noted or specified hereinafter all work shall conform to the applicable provisions of the Contract Documents. Bidders shall acknowledge receiving this document on the Bid Proposal Form.

THE BID DUE DATE HAS BEEN CHANGED AND SEALED BIDS ARE NOW DUE BY TUESDAY, NOVEMBER 14, 2023, 2:00 PM.

This Addendum includes four (4) pages and the following:

- 1. Pre-Bid Meeting Sign-In Sheet, dated 10/18/23, 1 page.
- 2. Addendum No. 1 (MEP Portion) as prepared by Gillan and Hartmann, Inc., dated 10/20/23, 4-pages.
- 3. New Specification Section: 283111, 8-pages.
- 4. Revised Drawings:
 - a. Architectural: G002, A101, A102, A103, A301, A401, A601, A701.
 - b. Plumbing: P001, P201.
 - c. Mechanical: H101, H102, H201, H202.
 - d. Electrical: E001, E101, E201, E202, E701.

REQUESTS FOR INFORMATION (RFI'S)

1. Question: On H202, between columns 31 & 32 and on Row V, there is a box with a reference to Note #8. But on that page there is no Note #8. Please clarify what item this is and what note it is referencing.

<u>Response</u>: Note #8 should be omitted, this is referencing work from the demolition sheet. Refer to drawing H202 revisions issued under Addendum #1 for clarity.

2. <u>Question</u>: On H202, near column 32 between Rows U & V there is a 2" vent with a label referencing SP-1. Is this an error and actually meaning to reference SE-1?

<u>Response</u>: This 2" vent is a reference from SE-1, not SP-1. Refer to drawing H202 revisions issued under Addendum #1 for clarity.

3. Question: Is a Structural Steel Subcontractor required to be named / listed in our Bid for this project?

<u>Response</u>: No. DPMC Classification C029 - Structural Steel & Ornamental Iron contractor **is not** identified in Section 00100 nor indicated on the Bid Proposal Form.

REFER TO DRAWINGS

The following Drawings and/or Sketches are attached to this Addendum:

DRAWING NO. TITLE

G002	GENERAL NOTES, DRAWING INDEX, AND ABBREVIATION INDEX
A101	EGRESS PLAN
A102	DEMOLITION, FLOOR, & REFLECTED CEILING PLANS; WALL PARTITION
	TYPES AND NOTES
A103	ROOF PLAN, DETAILS, AND NOTES
A301	WALL SECTIONS AND MISCELLANEOUS DETAILS
A401	ENLARGED ROOM LAYOUT
A601	DOOR & FRAME DETAILS, SCHEDULES, NOTES AND PLAN DETAILS
A701	FLOOR PATTERN LAYOUTS (NEW SHEET)

P001 P201	PLUMBING SYMBOLS, ABBREVIATIONS, & GENERAL NOTES PLUMBING FIRST FLOOR NEW WORK PLAN
H101	HVAC FIRST FLOOR DEMOLITION PLAN
H102	HVAC ROOF DEMOLITION PLAN
H201	HVAC FIRST FLOOR NEW WORK PLAN
H202	HVAC ROOF NEW WORK PLAN
E001	ELECTRICAL SYMBOL LEGEND
E101	LIGHTING AND POWER REMOVAL WORK
E201	LIGHTING AND POWER NEW WORK
E202	STEM LAB ROOF POWER AND FIRE ALARM NEW WORK
E701	ELECTRICAL DETAILS

The following Drawings to be revised or corrected as follows:

DRAWING NO. CHANGES AND CORRECTIONS

G002, A101, A102, A103, A301, A401, A601	Delete the referenced drawings in their entirety and substitute with the enclosed revised drawings.
P001, P201	Delete the referenced drawings in their entirety and substitute with the enclosed revised drawings.
H101, H102, H201, H202	Delete the referenced drawings in their entirety and substitute with the enclosed revised drawings.
E001, E101, E201, E202, E701	Delete the referenced drawings in their entirety and substitute with the enclosed revised drawings.

The following are new Drawing(s) to the bid set:

DRAWING NO. CHANGES AND CORRECTIONS

A701 Add the referenced drawing to the project bid set.

REFER TO SPECIFICATIONS

TABLE OF CONTENTS

Under Part - 6 Electrical Work, add the following new section which is attached to this Addendum:

283111 Fire Alarm System Modifications, 8 pages.

BID NOTICE

On the 10th line, change "Sealed Bids are due by Wednesday, November 8, 2023, 2:00 PM" to read "**Sealed Bids are due by Tuesday, November 14, 2023, 2:00 PM**".

PART 1 - SECTION 00100 - INSTRUCTIONS TO BIDDERS

Page Paragraph

00100-5 1.7, B. On the 3rd line, change "October 25, 2023", to read "November 1, 2023".

PART 1 - SECTION 01800 - TIME OF COMPLETION AND LIQUIDATED DAMAGES

Page Paragraph

01800-1 1.2, C. Delete subparagraph "2." in its entirety.

1.2, C.3 On the 2nd line, change "**after June 20, 2024 until August 30, 2024**", to read "**after June 24, 2024 until October 25, 2024.**"

a. Construction / Demolition activities are permitted if they **do not** disturb the school learning environment. Construction / Demolition activities which involve loud noise and/or odors shall only be done second shift.

PART 2 - SECTION 10900 - MISCELLANEOUS EQUIPMENT AND FURNISHINGS

Page Paragraph

10900-2 2.2 Delete subparagraph "A." in its entirety and substitute with the following:

- A. Basis of Design: "Model No. B-810 24 Spray Booth" as manufactured by BMC Fume Hoods + Lab Furniture; or approved equal.
 - 1. Spray Booth is constructed of 18 gage steel that is formed and welded into a rigid superstructure.
 - a. Refer to manufacturer's literature for Rough-in Details.
 - 2. Unit is finished with a chemical resistant powder coat paint finish and has a replaceable, pleated air filter.
 - 3. Non-explosion proof exhaust blower, Model No. 7C037 is mounted directly on top of the unit. A rectangular duct transition is included to connect the exhaust blower to the Spray Booth.
 - a. Outlet Size 4-1/4" x 7-3/8"
 - b. Motor is 115V/60HZ with 1/4 HP.
 - 4. Explosion Proof Light Fixture: Model F-260.
 - 5. Accessories:
 - a. Model F-262 Explosion proof receptacle.
 - b. Model F-264 Explosion proof switch.
 - c. Replacement Filters Model No. 6556 (16" x 20").
 - 1) Provide 36 spare filters as attic stock.
 - 6. Coordinate electrical and mechanical requirements with electrical and mechanical trades.

PART 6 - SECTION 283111 - FIRE ALARM SYSTEM MODIFICATION

Add new Section 283111, attached to this Addendum.

END OF ADDENDUM NO. 1



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 fax: 609.883.2694 Pennsylvania:
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PRO	JECT	NA	ME:
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STEM Lab Alterations & Renovations at

Clearview Regional Middle School

DATE:_	Wednesday,	October	18,	2023	at	2:00	PM
FVHD I	PROIECT#:	5162	C				

PRE-BID MEETING SIGN-IN SHEET

REPRESENTATIVE NAME (Please Print)	COMPANY NAME & ADDRESS	CONTRACT NUMBER	TELEPHONE#	FAX#	E-MAIL
Gregory	Capri Construction Co., Inc.		X (-642-	DS6-646-	9 reg @ capricon struction
Capriotal	4266 Post Rand Vineland, No cB360		4769	3624	Cd. Com
DAN SOLITIONE	+V410				
BRIAN BURTON	Clereview Retrant				,
Joenarino	Marino General Const. Inc. 9895.main St. winster MT	689-685 6135	5		Joe@Marinogc.net Nmarino \$168@ yahoo.com
Joshlay	Ley Constrution 10 Goo Newton Ale Cultyn, NJ		816-547 0707	为对	Joshe Lew Carth
PEUNIS STUKEPA	STNUCK PROTHURS		856481-7866	€C6-8€6 €853	Dervis & STANGE PROTHES, WET

ADDENDUM NO. 1 (MEP portion)

to the

SPECIFICATIONS AND DRAWINGS

for the

NEW STEM LAB AT CLEARVIEW REGIONAL MIDDLE SCHOOL IN CLEARVIEW REGIONAL HIGH SCHOOL DISTRICT

Located at

595 Jefferson Rd, Mullica Hill, New Jersey 08062



- 1. MEP Addendum No. 1 dated October 20, 2023, is issued as part of the Contract Documents, dated October 11, 2023 to inform and/or specify changes, which take precedence over information contained in the original Contract Documents. Unless otherwise specifically noted or specified hereinafter, or shown on drawings or schedules accompanying this Addendum, all work required by this Addendum shall conform to the applicable provisions of the Contract Documents. It shall be the responsibility of the Bidder to include in their bid any cost implications of this Addendum. All Bidders are to indicate on the form of proposal submitted by them, acknowledgment of receipt and compliance with the contents of this change to the Contract Documents.
- 2. Any provision in any of the Contract Documents which may be in conflict or be inconsistent with the contents of this Addendum shall be void to the extent of such conflict or inconsistency.
- 3. HVAC TRADE
 - 3.1 CLARIFICATIONS:
 - 3.1.1. None.
 - 3.2 ERRATA IN THE SPECIFICATIONS
 - 3.2.1. None.
 - 3.3 ERRATA ON THE DRAWINGS
 - 3.3.1. Drawing H101 HVAC First Floor Demolition Plan: Drawing keyed notes adjusted for clarity.
 - 3.3.2. Drawing H102 HVAC Roof Demolition Plan: Drawing keyed notes adjusted for clarity.
 - 3.3.3. Drawing H201 HVAC First Floor New Work Plan: Removed "Not For Construction" tag, Revised T-Stat location, Added Vent relief for Storage Cabinet and Drawing keyed notes adjusted for clarity.
 - 3.3.4. Drawing H202 HVAC Roof New Work Plan: Removed miscellaneous dimension not used, Removed keynote not used and Drawing keyed notes adjusted for clarity.
- 4. PLUMBING TRADE
 - 4.1 CLARIFICATIONS:
 - 4.1.1. None.
 - 4.2 ERRATA IN THE SPECIFICATIONS
 - 4.2.1. None.

G&H: 2022-197 FVHD: #5162C

4.3 ERRATA ON THE DRAWINGS:

- 4.3.1. Drawing P001 Plumbing Symbols, Abbreviations, & General Notes: Removed "Not For Construction" tag and Drawing General notes adjusted for clarity.
- 4.3.2. Drawing P101 Plumbing First Floor Demolition Plan: Removed "Not For Construction" tag.
- 4.3.3. Drawing P201 Plumbing First Floor New Work Plan: Removed "Not For Construction" tag and Drawing General notes adjusted for clarity.
- 4.3.4. Drawing P501 Plumbing Details, Diagrams & Schedules: Removed "Not For Construction" tag, replaced Penetration Details and Plumbing Fixture Schedule adjusted for clarity.

5. ELECTRICAL TRADE

- 5.1 CLARIFICATIONS:
 - 5.1.1. None.
- 5.2 ERRATA IN THE SPECIFICATIONS
 - 5.2.1. Add the attached Specification 283111. Section 260923.
- 5.3 ERRATA ON THE DRAWINGS:
 - 5.3.1. Drawing E001:
 - 5.3.1.1. Changed symbol descriptions and notes as indicated.
 - 5.3.1.2. Added light fixture to the Lighting Fixture Schedule.
 - 5.3.1.3. Additional modifications and additions as indicated.
 - 5.3.2. Drawing E101:
 - 5.3.2.1. Modifications and additions as indicated.
 - 5.3.3. Drawing E201:
 - 5.3.3.1 Added lighting equipment in Secure Storage 305B.
 - 5.3.4.2 Added power poles and branch circuits to tables in Lab/Robotics Area 305A.
 - 5.3.3.3 Added exterior light fixture outside of Lab/Robotics Area 305A.
 - 5.3.3.4 Removed exit sign in Stem Classroom 305 at door leading into Lab/Robotics Area 305A.
 - 5.3.3.5 Additional modifications and additions as indicated.
 - 5.3.4. Drawing E202:

G&H: 2022-197 FVHD: #5162C 5.3.4.1 Modifications and additions as indicated.

5.3.5. Drawing E701:

5.3.5.1 Added panelboard branch circuits and modifications as indicated.

END OF ADDENDUM NO. 1

G&H: 2022-197 FVHD: #5162C

SECTION 283111 - FIRE ALARM SYSTEM MODIFICATIONS

PART 1 - GENERAL

1.1 RELATED DOCUMENTS

A. Drawings and general provisions of the Contract, including General and Supplementary Conditions and Division 01 Specification Sections, apply to this Section.

1.2 SUMMARY

- A. This Section includes requirements for the modification and expansion of the Siemens fire alarm system at the Clearview Regional Middle School. The fire alarm system was installed in 2023 and is maintained by Siemens Fire Safety Branch (Contact Mr. Lucas Baker Telephone 856-234-7666 and email lucas.baker@siemens.com.
- B. The project includes requirements to add a new duct mounted smoke detector, multiple voice audio & visual fire alarm indicators, and relocate an existing fire alarm pull station. See the drawings for additional requirements.
- C. All equipment and material provided for the fire alarm system shall be fully compatible with the existing Siemens fire alarm system.
- D. Coordinate with the equipment manufacturer's representatives listed on the drawings to obtain the requirements to modify the existing systems as shown on the drawings and include in the bid price the costs to provide all required equipment, labor and material to modify the existing systems as shown on the drawings.
- E. After the modifications to the existing fire alarm system are complete, test the system in compliance with the requirements of the Local Authority Having Jurisdiction and NFPA 72.

1.3 DEFINITIONS

- A. FACP: Fire alarm control panel.
- B. LED: Light-emitting diode.
- C. NICET: National Institute for Certification in Engineering Technologies.
- D. Definitions in NFPA 72 apply to fire alarm terms used in this Section.

1.4 SYSTEM DESCRIPTION

- A. The existing fire alarm system is a Siemens System. All new equipment shall be fully compatible with the existing fire alarm system.
- B. Coordinate with the manufacturer and provide all equipment, labor, hardware, and material to modify the existing system as shown on the drawings.

1.5 SUBMITTALS

- A. Product Data: For each type of product indicated.
- B. Shop Drawings:
 - 1. Provide shop drawings that are signed and sealed by a Professional Engineer with the following qualifications:
 - a. Trained and certified by manufacturer in fire alarm system design.
 - b. Fire alarm certified by NICET, minimum Level III.
 - 2. System Operation Description: Detailed description for this Project, including method of operation and supervision of each type of circuit and sequence of operations for manually and automatically initiated system inputs and outputs. Manufacturer's standard descriptions for generic systems are not acceptable.
 - 3. Device Address List: Coordinate with final system programming.
 - 4. System riser diagram with device addresses, conduit sizes, and cable and wire types and sizes.
 - 5. Wiring Diagrams: Power, signal, and control wiring. Include diagrams for equipment and for system with all terminals and interconnections identified. Show wiring color code.
 - 6. Batteries: Size calculations.
 - 7. Ductwork Coordination Drawings: Plans, sections, and elevations of ducts, drawn to scale and coordinate the installation of duct smoke detectors and access to them. Show critical dimensions that relate to placement and support of sampling tubes, the detector housing, and remote status and alarm indicators. Locate detectors according to manufacturer's written recommendations.
- C. Qualification Data: For Installer.
- D. Field quality-control test reports.
- E. Operation and Maintenance Data: For fire alarm system to include in emergency, operation, and maintenance manuals. Comply with NFPA 72, Appendix A, recommendations for Institution's manual. Include abbreviated operating instructions for mounting at the FACP.
- F. The shop drawings shall include signed and sealed (By a NICET qualified Professional Engineer) floorplans (showing the locations of all devices), wiring diagrams, riser diagrams, battery calculations and all additional NFPA 72 requirements.
- G. Submittals to Authorities Having Jurisdiction: In addition to distribution requirements for submittals specified in Division 01 Section "Submittals," make an identical submittal to

authorities having jurisdiction for review and approval prior to submission to the Professional. To facilitate review, include copies of annotated Contract Drawings as needed to depict component locations. Resubmit if required to make clarifications or revisions to obtain approval. On receipt of comments from authorities having jurisdiction, submit them to Professional for review.

H. Documentation:

- 1. Approval and Acceptance: Provide the "Record of Completion" form according to NFPA 72 to Institution, Professional, and authorities having jurisdiction.
- 2. Record of Completion Documents: Provide the "Permanent Records" according to NFPA 72 to Institution, Professional, and authorities having jurisdiction. The format of the written sequence of operation shall be the optional input/output matrix.
 - a. Hard copies on paper to Institution, Professional, and authorities having jurisdiction.

1.6 QUALITY CONTROL

- A. Installer Qualifications: Personnel certified by NICET as Fire Alarm Level II.
- B. Electrical Components, Devices, and Accessories: Listed and labeled as defined in NFPA 70, Article 100, by a testing agency acceptable to authorities having jurisdiction, and marked for intended use.

1.7 PROJECT CONDITIONS

- A. Interruption of Existing Fire Alarm Service: Do not interrupt fire alarm service to facilities occupied by Institution or others unless permitted under the following conditions and then only after arranging to provide temporary guard service according to requirements indicated:
 - 1. Notify the District no fewer than five days in advance of proposed interruption of fire alarm service.
 - 2. Do not proceed with interruption of fire alarm service without District's written permission.

1.8 SEQUENCING AND SCHEDULING

- A. Existing Fire Alarm Equipment: Maintain fully operational until new equipment has been tested and accepted. As new equipment is installed, label it "NOT IN SERVICE" until it is accepted. Remove labels from new equipment when put into service and label existing fire alarm equipment "NOT IN SERVICE" until removed from the building.
- B. Equipment Removal: After acceptance of the new fire alarm system, remove existing disconnected fire alarm equipment.

2.1 EXISTING FIRE ALARM SYSTEM

A. Provide equipment that is fully compatible with the existing fire alarm system.

2.2 SYSTEM SMOKE DETECTORS

A. Duct Smoke Detectors:

- 1. Photoelectric Smoke Detectors:
 - a. Sensor: LED or infrared light source with matching silicon-cell receiver.
 - b. Detector Sensitivity: Between 2.5 and 3.5 percent/foot smoke obscuration when tested according to UL 268A.
- 2. UL 268A listed, operating at 24-V dc, nominal.
- 3. Integral Addressable Module: Arranged to communicate detector status (normal, alarm, or trouble) to the FACP.
- 4. Plug-in Arrangement: Detector and associated electronic components shall be mounted in a plug-in module that connects to a fixed base. The fixed base shall be designed for mounting directly to the air duct. Provide terminals in the fixed base for connection to building wiring.
 - a. Weatherproof Duct Housing Enclosure: UL listed for use with the supplied detector. The enclosure shall comply with NEMA 250 requirements for Type 4X.
- 5. Self-Restoring: Detectors shall not require resetting or readjustment after actuation to restore them to normal operation.
- 6. Integral Visual-Indicating Light: LED type. Indicating detector has operated and power-on status. Provide remote status and alarm indicator and test station where indicated.
- 7. Remote Control: Unless otherwise indicated, detectors shall be analog-addressable type, individually monitored at the FACP for calibration, sensitivity, and alarm condition, and individually adjustable for sensitivity from the FACP.
- 8. Each sensor shall have multiple levels of detection sensitivity.
- 9. Sampling Tubes: Design and dimensions as recommended by manufacturer for the specific duct size, air velocity, and installation conditions where applied.
- 10. Relay Fan Shutdown: Rated to interrupt fan motor-control circuit & relay for smoke damper.

2.3 NOTIFICATION APPLIANCES

A. General Requirements for Notification Appliances: Individually addressed, connected to a signaling-line circuit, equipped for mounting as indicated, and with screw terminals for system connections.

Combination Devices: Factory-integrated audible and visible devices in a single-mounting

assembly, equipped for mounting as indicated, and with screw terminals for system connections.

Visible Notification Appliances: Xenon strobe lights complying with UL 1971, with clear or nominal white polycarbonate lens mounted on an aluminum faceplate. The word "FIRE" is engraved in minimum 1-inch high letters on the lens.

Rated Light Output:

Candela output selected as shown on the drawings.

All strobes shall be 15/30/75/110 cd, selectable in the field.

Mounting: Wall mounted unless otherwise indicated.

For units with guards to prevent physical damage, light output ratings shall be determined with guards in place.

Flashing shall be in a temporal pattern, synchronized with other units.

Strobe Leads: Factory connected to screw terminals.

Mounting Faceplate: Factory finished, red.

Voice/Tone Notification Appliances:

Comply with UL 1480.

Speakers for Voice Notification: Locate speakers for voice notification to provide the intelligibility requirements of the "Notification Appliances" and "Emergency Communications Systems" chapters in NFPA 72.

High-Range and Low Range Units: Provide wattage as required to achieve the requirement of 15dbA above the existing ambient noise level.

Mounting: Flush or surface mounted and bidirectional.

Matching Transformers: Tap range matched to acoustical environment of speaker location.

The Contractor is to provide voice alarm speakers that provide an output of 15dbA above the existing ambient noise level in each of the rooms where voice alarm speakers are indicated.

2.3 WIRE AND CABLE

- A. Wire and cable for fire alarm systems shall be UL listed and labeled as complying with NFPA 70, Article 760.
- B. Signaling Line Circuits: Twisted, shielded pair, size as recommended by system manufacturer.
- C. Non-Power-Limited Circuits: Solid-copper conductors in raceway with 600-V rated, 75 deg C, color-coded insulation.
 - 1. Low-Voltage Circuits: No. 16 AWG, minimum.
 - 2. Line-Voltage Circuits: No. 12 AWG, minimum.

PART 3 - EXECUTION

3.1 EQUIPMENT INSTALLATION

- A. Connecting to Existing Equipment: Verify that existing fire alarm system is operational before making changes or connections.
 - 1. Connect new equipment to the existing control panel in the existing part of the building.
 - 2. Connect new equipment to the existing monitoring equipment at the Supervising Station.
 - 3. Expand, modify, and supplement the existing equipment as necessary to extend the existing functions to the new points. New components shall be capable of merging with the existing configuration without degrading the performance of either system.
- B. Smoke or Heat Detector Spacing:
 - 1. Smooth ceiling spacing shall not exceed 30 feet.
 - 2. Spacing of heat detectors for irregular areas, for irregular ceiling construction, and for high ceiling areas, shall be determined according to Appendix A in NFPA 72.
 - 3. Spacing of heat detectors shall be determined based on guidelines and recommendations in NFPA 72.
- C. HVAC: Locate detectors not closer than 3 feet from air-supply diffuser or return-air opening.
- D. Duct Smoke Detectors: Comply with NFPA 72 and NFPA 90A. Install sampling tubes so they extend the full width of the duct. Provide wiring to shut down fan and operate smoke dampers
- E. Audible Alarm-Indicating Devices: Install not less than 6 inches below the ceiling. Install bells and horns on flush-mounted back boxes with the device-operating mechanism concealed behind a grille.
- F. Visible Alarm-Indicating Devices: Install adjacent to each alarm bell or alarm horn and at least 6 inches below the ceiling.
- G. Device Location-Indicating Lights: Locate in public space near the device they monitor.

3.2 WIRING INSTALLATION

- A. Install wiring according to the following:
 - 1. NECA 1.
 - 2. TIA/EIA 568-A.
- B. Wiring Method: Install wiring in metal raceway according to Division 26.
 - 1. Fire alarm circuits and equipment control wiring associated with the fire alarm system shall be installed in a dedicated raceway system. This system shall not be used for any other wire or cable.
- C. Wiring within Enclosures: Separate power-limited and non-power-limited conductors as recommended by manufacturer. Install conductors parallel with or at right angles to sides and back of the enclosure. Bundle, lace, and train conductors to terminal points with no excess. Connect conductors that are terminated, spliced, or interrupted in any enclosure associated with the fire alarm system to terminal blocks. Mark each terminal according to the system's wiring diagrams. Make all connections with approved crimp-on terminal spade lugs, pressure-type terminal blocks, or plug connectors.
- D. Cable Taps: Use numbered terminal strips in junction, pull, and outlet boxes, cabinets, or equipment enclosures where circuit connections are made.
- E. Color-Coding: Color-code fire alarm conductors differently from the normal building power wiring. Use one color-code for alarm circuit wiring and a different color-code for supervisory circuits. Color-code audible alarm-indicating circuits differently from alarm-initiating circuits. Use different colors for visible alarm-indicating devices. Paint fire alarm system junction boxes and covers red.
- F. Risers: Install at least two vertical cable risers to serve the fire alarm system. Separate risers in close proximity to each other with a minimum 1-hour-rated wall, so the loss of one riser does not prevent the receipt or transmission of signals from other floors or zones.

3.3 IDENTIFICATION

- A. Identify system components, wiring, cabling, and terminals according to Division 26.
- B. Install instructions frame in a location visible from the FACP.
- C. Paint power-supply disconnect switch red and label "FIRE ALARM."

3.4 GROUNDING

A. Ground the FACP and associated circuits; comply with IEEE 1100. Install a ground wire from main service ground to the FACP.

3.5 FIELD QUALITY CONTROL

- A. Manufacturer's Field Service: Engage a factory-authorized service representative to inspect, test, and adjust field-assembled components and equipment installation, including connections, and to assist in field testing. Report results in writing.
- B. Perform the following field tests and inspections and prepare test reports:
 - 1. Before requesting final approval of the installation, submit a written statement using the form for Record of Completion shown in NFPA 72.
 - Perform each electrical test and visual and mechanical inspection listed in NFPA 72.
 Certify compliance with test parameters. All tests shall be conducted under the direct supervision of a NICET technician certified under the Fire Alarm Systems program at Level III.
 - a. Include the existing system in tests and inspections.
 - 3. Visual Inspection: Conduct a visual inspection before any testing. Use as-built drawings and system documentation for the inspection. Identify improperly located, damaged, or nonfunctional equipment, and correct before beginning tests.
 - 4. Testing: Follow procedure and record results complying with requirements in NFPA 72.
 - 5. Test and Inspection Records: Prepare according to NFPA 72, including demonstration of sequences of operation by using the matrix-style form in Appendix A in NFPA 70.


3.6 ADJUSTING

- A. Occupancy Adjustments: When requested within 12 months of date of Substantial Completion, provide on-site assistance in adjusting system to suit actual occupied conditions. Provide up to two visits to Project outside normal occupancy hours for this purpose.
- B. Follow-Up Tests and Inspections: After date of Substantial Completion, test the fire alarm system complying with testing and visual inspection requirements in NFPA 72. Perform tests and inspections listed for three monthly, and one quarterly, periods.

3.7 DEMONSTRATION


A. Engage a factory-authorized service representative to train Institution's maintenance personnel to adjust, operate, and maintain the fire alarm system, appliances, and devices.

END OF SECTION 283111

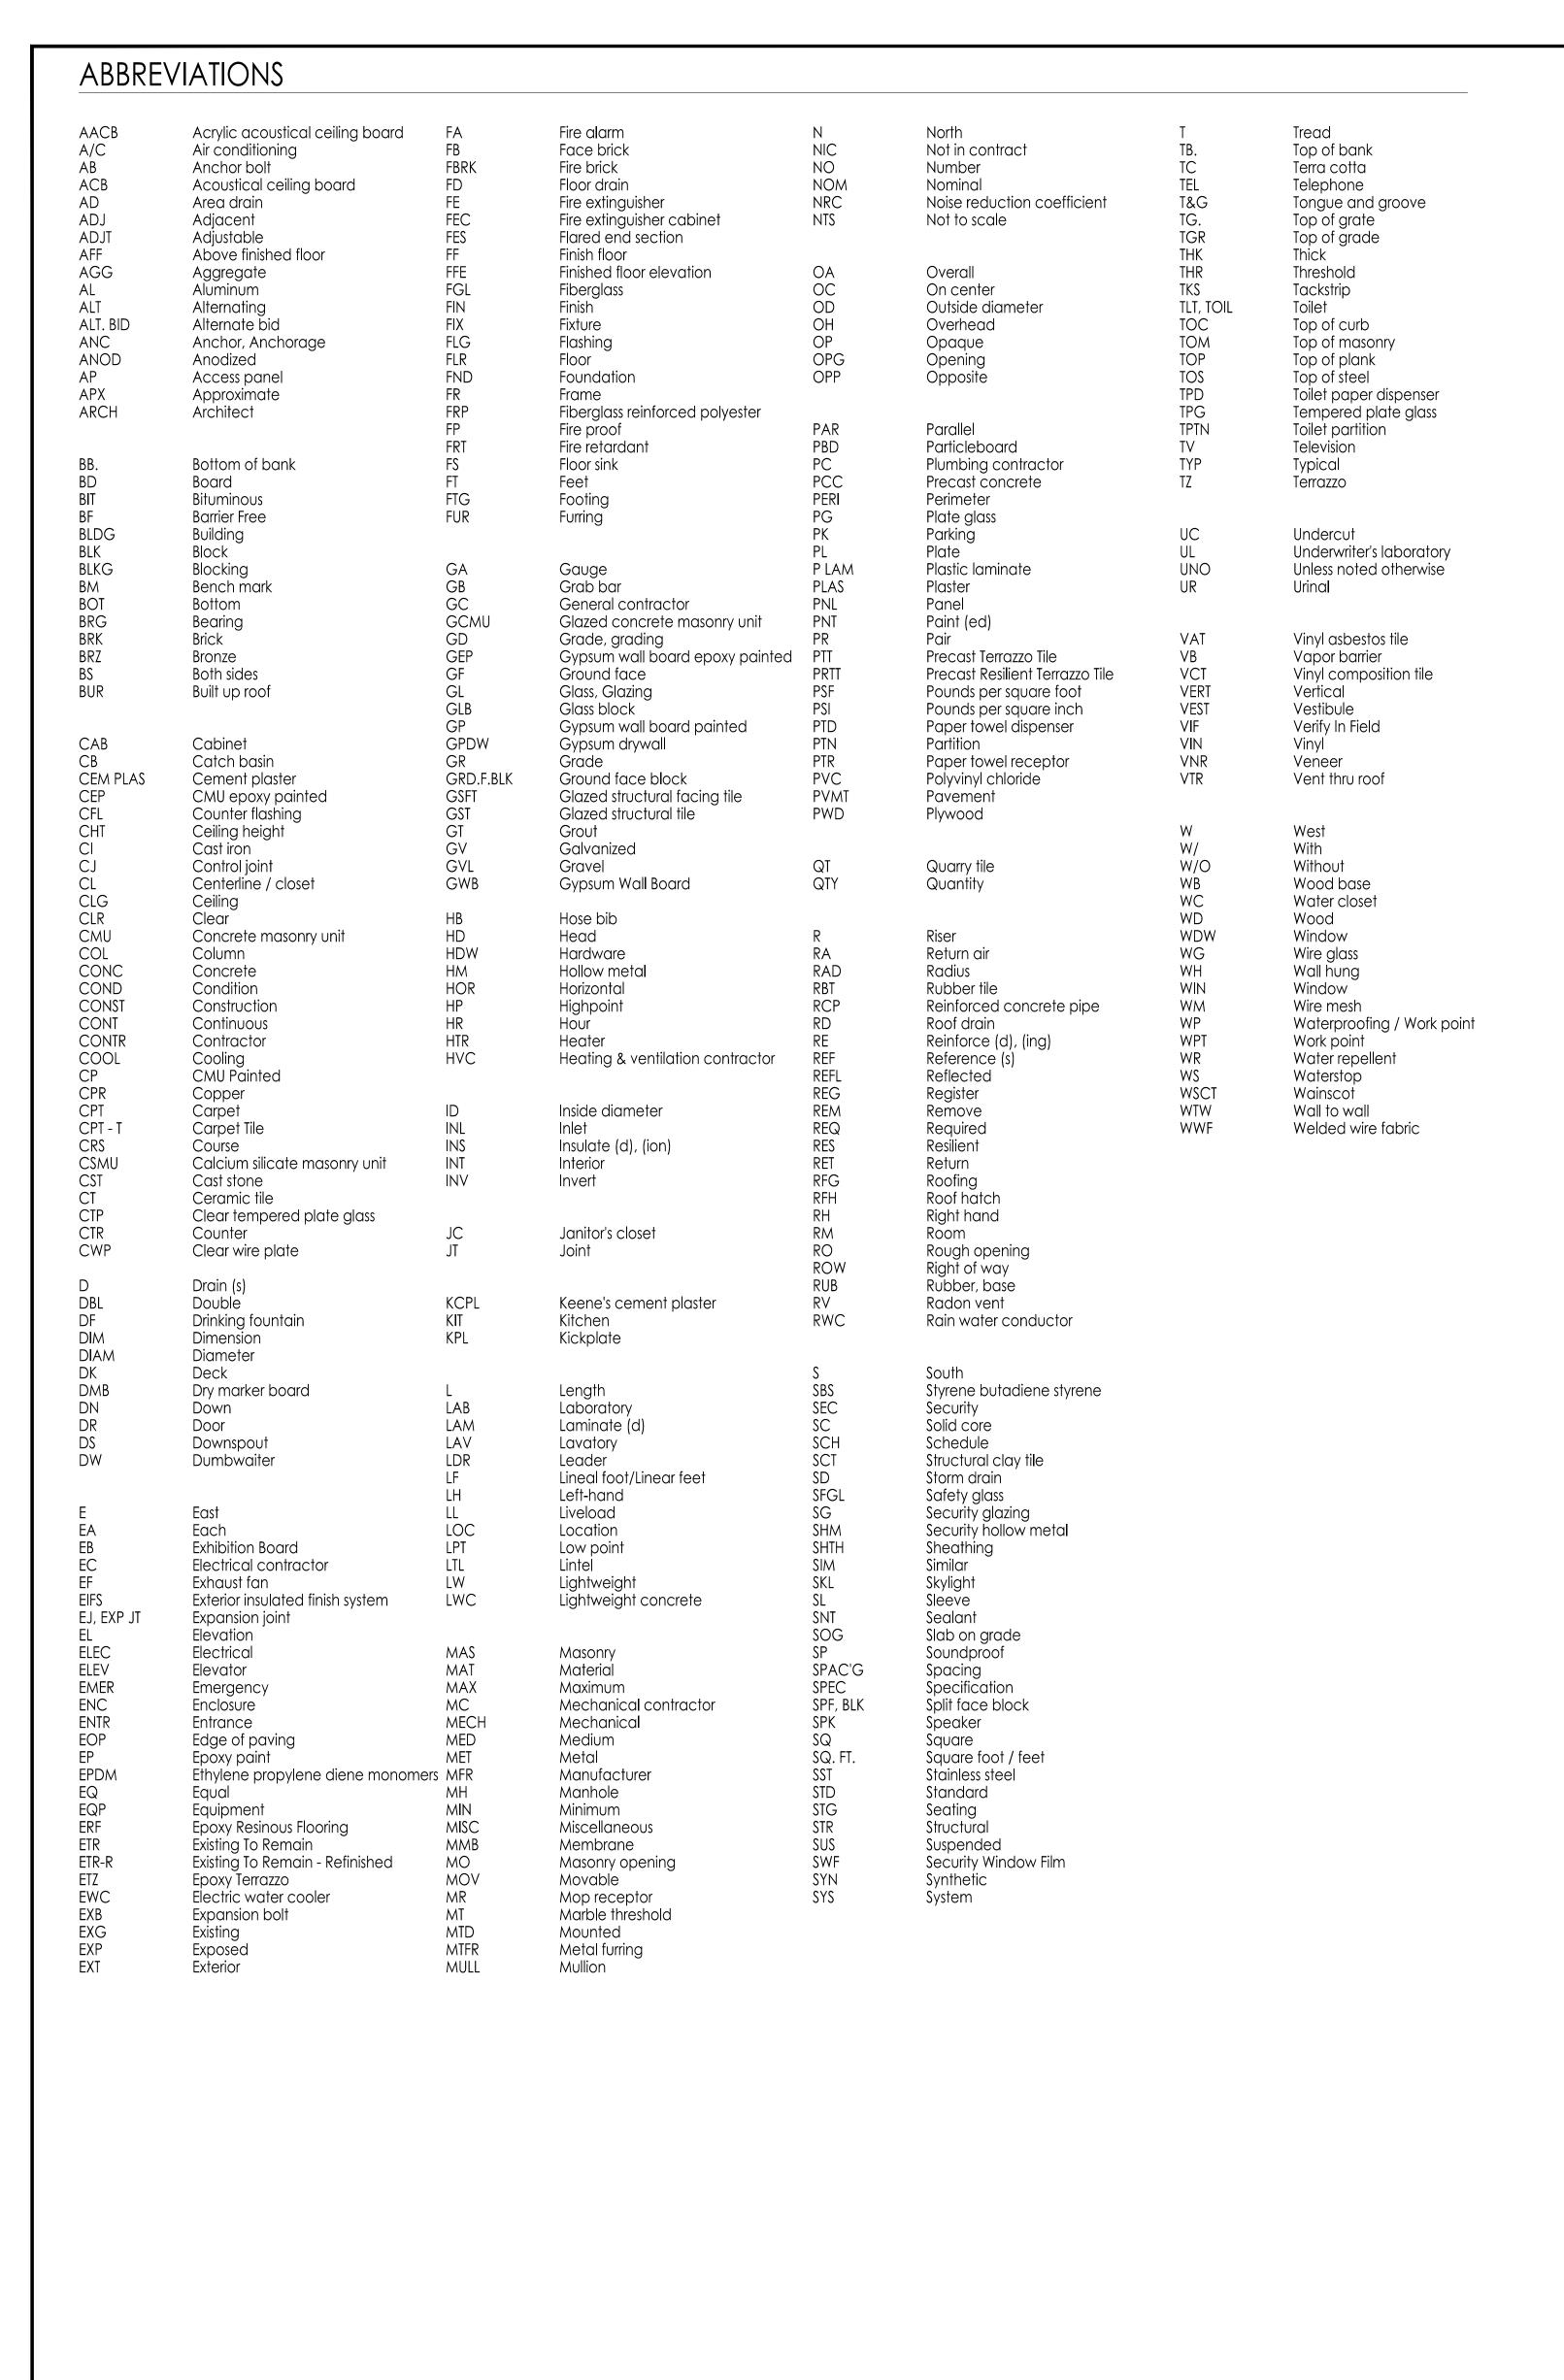

GENERAL NOTES DRAWING INDEX 1. ALL CONTRACTORS SHALL VISIT THE SITE AND VERIFY ALL EXISTING CONDITIONS BEFORE SUBMITTING A BID. DISCREPANCIES OR OMISSIONS MUST BE REPORTED TO THE GENERAL ARCHITECT IN WRITING (10) DAYS PRIOR TO BID OPENING. IF HE OR SHE DOES NOT, CONTRACTOR SHALL CORRECT SAME AT NO CHANGE IN CONTRACT PRICE. TITLE SHEET 2. CONTRACTOR SHALL PROVIDE ALL REQUIRED SAFETY PROTECTION DURING GENERAL NOTES, DRAWING INDEX, AND ABBREVIATION INDEX CONSTRUCTION. 3. IT SHALL BE THE CONTRACTORS RESPONSIBILITY TO PROVIDE A SUFFICIENT WORK FORCE ARCHITECTURAL TO MEET COMPLETION DATES AS OUTLINED IN THE SPECIFICATIONS. NO EXCEPTIONS WILL BE ALLOWED. EGRESS PLAN 4. DO NOT SCALE THE DRAWINGS. DEMOLITION, FLOOR, & REFLECTED CEILING PLANS; WALL PARTITION TYPES AND NOTES 5. DETAILS NOTED "TYPICAL" IMPLY ALL SUCH CONDITIONS BE TREATED SIMILARLY. ROOF PLAN, DETAILS, AND NOTES 6. MATERIALS LISTED ON THE FINISH SCHEDULE REFER TO THE MAJORITY OF WALLS, FLOOR WALL SECTIONS AND MISCELLANEOUS DETAILS AND CEILING OF ROOMS SCHEDULED, REFER TO PLANS, DETAILS, INTERIOR ELEVATION, CEILING PLANS, AND NOTES FOR THOSE MATERIALS NOT INDICATED ON THE SCHEDULE ENLARGED ROOM LAYOUT BUT ARE STILL REQUIRED IN THE ROOM. A601 DOOR & FRAME DETAILS, SCHEDULES, NOTES AND PLAN DETAILS 7. UNLESS OTHERWISE NOTED AND UNLESS FACTORY FINISHED, ALL EXPOSED SURFACES OF FLOOR PATTERN LAYOUTS CMU, CONCRETE, PLASTER, WOOD, GYPSUM BOARD, HOLLOW METAL, HARDWOODS, MECHANICAL MISC. METALS ETC., ARE TO RECEIVE PRIME AND FINISH COATS OF PAINT OR CLEAR FINISH AS SPECIFIED AND IN COLORS AS SELECTED BY ARCHITECT. EXCLUDED FROM THIS HVAC SYMBOLS, ABBREVIATIONS, AND GENERAL NOTES HVAC FIRST FLOOR DEMOLITION PLAN 8. ALL OUTSIDE CORNERS OF INTERIOR CONCRETE MASONRY UNITS (CMU) ARE TO BE BULLNOSED UNLESS NOTED OTHERWISE. HVAC ROOF DEMOLITION PLAN HVAC FIRST FLOOR NEW WORK PLAN 9. CALL BEFORE YOU DIG. BEFORE DIGGING CONTRACTOR SHALL CALL 1-800-242-1776 TO HAVE UTILITIES IDENTIFY UNDERGROUND LOCATION OF ALL SERVICE LINES. HVAC ROOF NEW WORK PLAN 10. ALL WORK PERTAINING TO THESE DRAWINGS SHALL BE PERFORMED IN ACCORDANCE HVAC DETAILS & SCHEDULES WITH ALL APPLICABLE STATE AND LOCAL CODES AND IN AGREEMENT WITH ALL HVAC CHILLED WATER / HOT WATER DIAGRAMS AGENCIES HAVING JURISDICTION. 11. THE CONTRACTOR IS RESPONSIBLE TO SECURE ALL PERMITS, TO OBTAIN APPROVALS AS ELECTRICAL REQUIRED AND COORDINATE INSPECTION WITH LOCAL BUILDING INSPECTOR. ALL PERMIT AND APPLICATION FEES WILL BE PAID BY THE OWNER AND DELIVERED BY THE CONTRACTOR. ELECTRICAL SYMBOL LEGEND 12. DRAWINGS AND SPECIFICATIONS COMPLEMENT EACH OTHER. WORK NOT SHOWN ON LIGHTING AND POWER REMOVAL WORK DRAWING BUT CALLED FOR IN THE SPECIFICATIONS IS STILL REQUIRED, AND ALL WORK LIGHTING AND POWER NEW WORK NOT CALLED FOR IN SPECIFICATIONS, BUT CALLED OUT OR SHOWN IN DRAWINGS IS STILL REQUIRED. STEM LAB ROOF POWER AND FIRE ALARM NEW WORK ELECTRICAL DETAILS 13. THE OWNER WILL REMOVE AND RE-INSTALL ALL MOVEABLE EQUIPMENT. EACH CONTRACTOR IS RESPONSIBLE TO REMOVE, STORE AND RE-INSTALL EXISTING BUILT-IN

PLUMBING

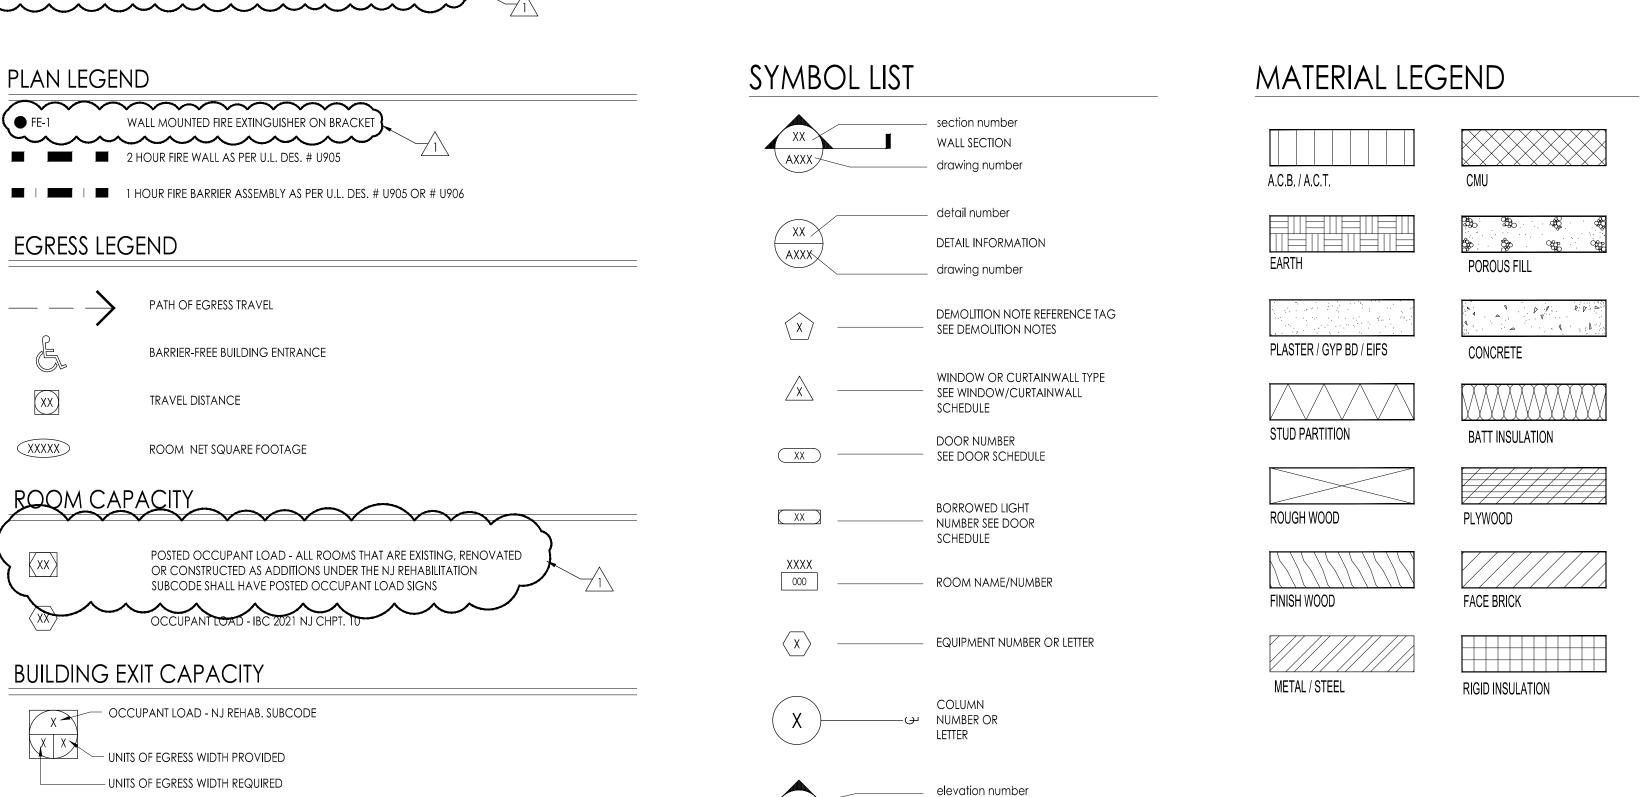

INTERIOR ELEVATION


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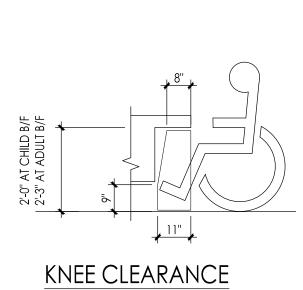
PLUMBING SYMBOLS, ABBREVIATIONS, & GENERAL NOTES

PLUMBING FIRST FLOOR DEMOLITION PLAN

PLUMBING DETAILS, DIAGRAMS, & SCHEDULES

PLUMBING FIRST FLOOR NEW WORK PLAN



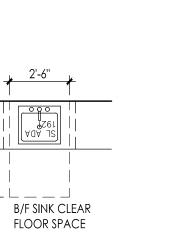

EQUIPMENT REQUIRED TO PERFORM THEIR WORK UNLESS NOTED OTHERWISE.

14. IN ACCORDANCE WITH NJAC 5:23-6.6(i), ALL MATERIALS AND METHODS USED SHALL

METHODS.

PLAN LEGEND

EGRESS LEGEND

COMPLY WITH THE REQUIREMENTS SPECIFIED IN N.J.A.C. 5:23-6.8, MATERIALS AND

15. WHERE THERE IS AN ACCESSIBLE CONCEALED FLOOR, FLOOR-CEILING OR ATTIC SPACE,

AND/OR SMOKE PROTECTED ASSEMBLY MARKING DETAIL. REFER TO G003 FOR DETAIL.

DOOR SHALL REMAIN IN PLACE AND INACCESSIBLE DURING CONSTRUCTION.

6. CONSTRUCTION AREA IS LIMITED TO WORK AREA SHOWN ON SHEET A 101.

2 HOUR FIRE WALL AS PER U.L. DES. # U905

PATH OF EGRESS TRAVEL

TRAVEL DISTANCE

BUILDING EXIT CAPACITY

OCCUPANT LOAD - NJ REHAB. SUBCODE

—— UNITS OF EGRESS WIDTH REQUIRED

OCCUPANT LOAD - IBC 2021 NJ CHPT. 10

NET CLEAR EGRESS WIDTH PROVIDED (IN INCHES)

———— NET CLEAR EGRESS WIDTH REQUIRED (IN INCHES)

UNITS OF EGRESS WIDTH PROVIDED

BARRIER-FREE BUILDING ENTRANCE


ROOM NET SQUARE FOOTAGE


FIRE WALLS, FIRE BARRIERS, FIRE PARTITIONS, SMOKE BARRIERS AND SMOKE PARTITIONS

SHALL BE EFFECTIVELY AND PERMANENTLY IDENTIFIED IN ACCORDANCE WITH THE FIRE

CONSTRUCTION WORK IS LIMITED TO REAR DOOR OF WORK AREA ONLY. CORRIDOR


OR ANY OTHER WALL REQUIRED TO HAVE PROTECTED OPENINGS OR PENETRATIONS

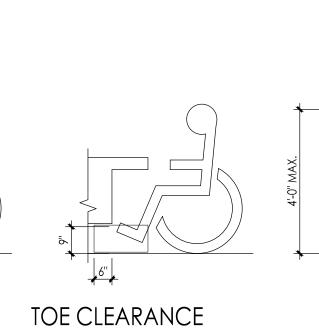

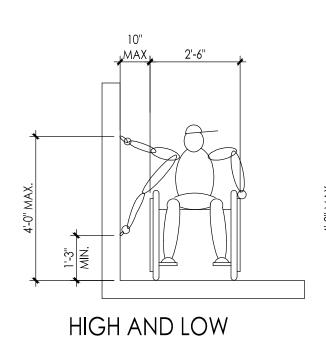


UNOBSTRUCTED SIDE

REACH LIMITS

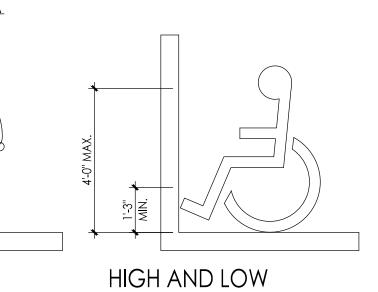


UNOBSTRUCTED

FORWARD REACH LIMITS

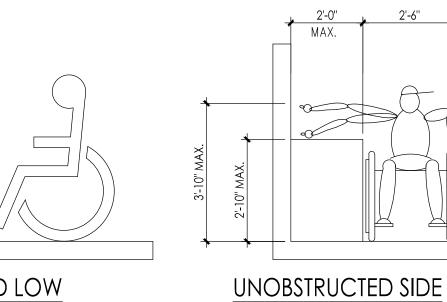

REACH LIMITS

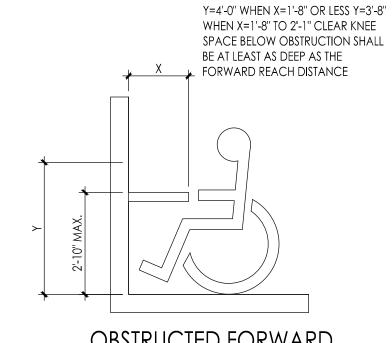

OBSTRUCTED FORWARD

REACH LIMITS

Drawing Number G002

No. Date Description

10.20.23 ADDENDUM 1

STEM Lab Alterations

Clearview Regional

Clearview Regional

High School District

595 Jefferson Rd,

Mullica Hill, NJ

& Renovations at

Middle School

Project Owner Name

Project Location

08062

Project Number

5162C

Project Date

Checked By

Drawn By

AS NOTED


Drawing Name

GENERAL NOTES,

DRAWING INDEX, AND

ABBREVIATION LIST

10/11/2023

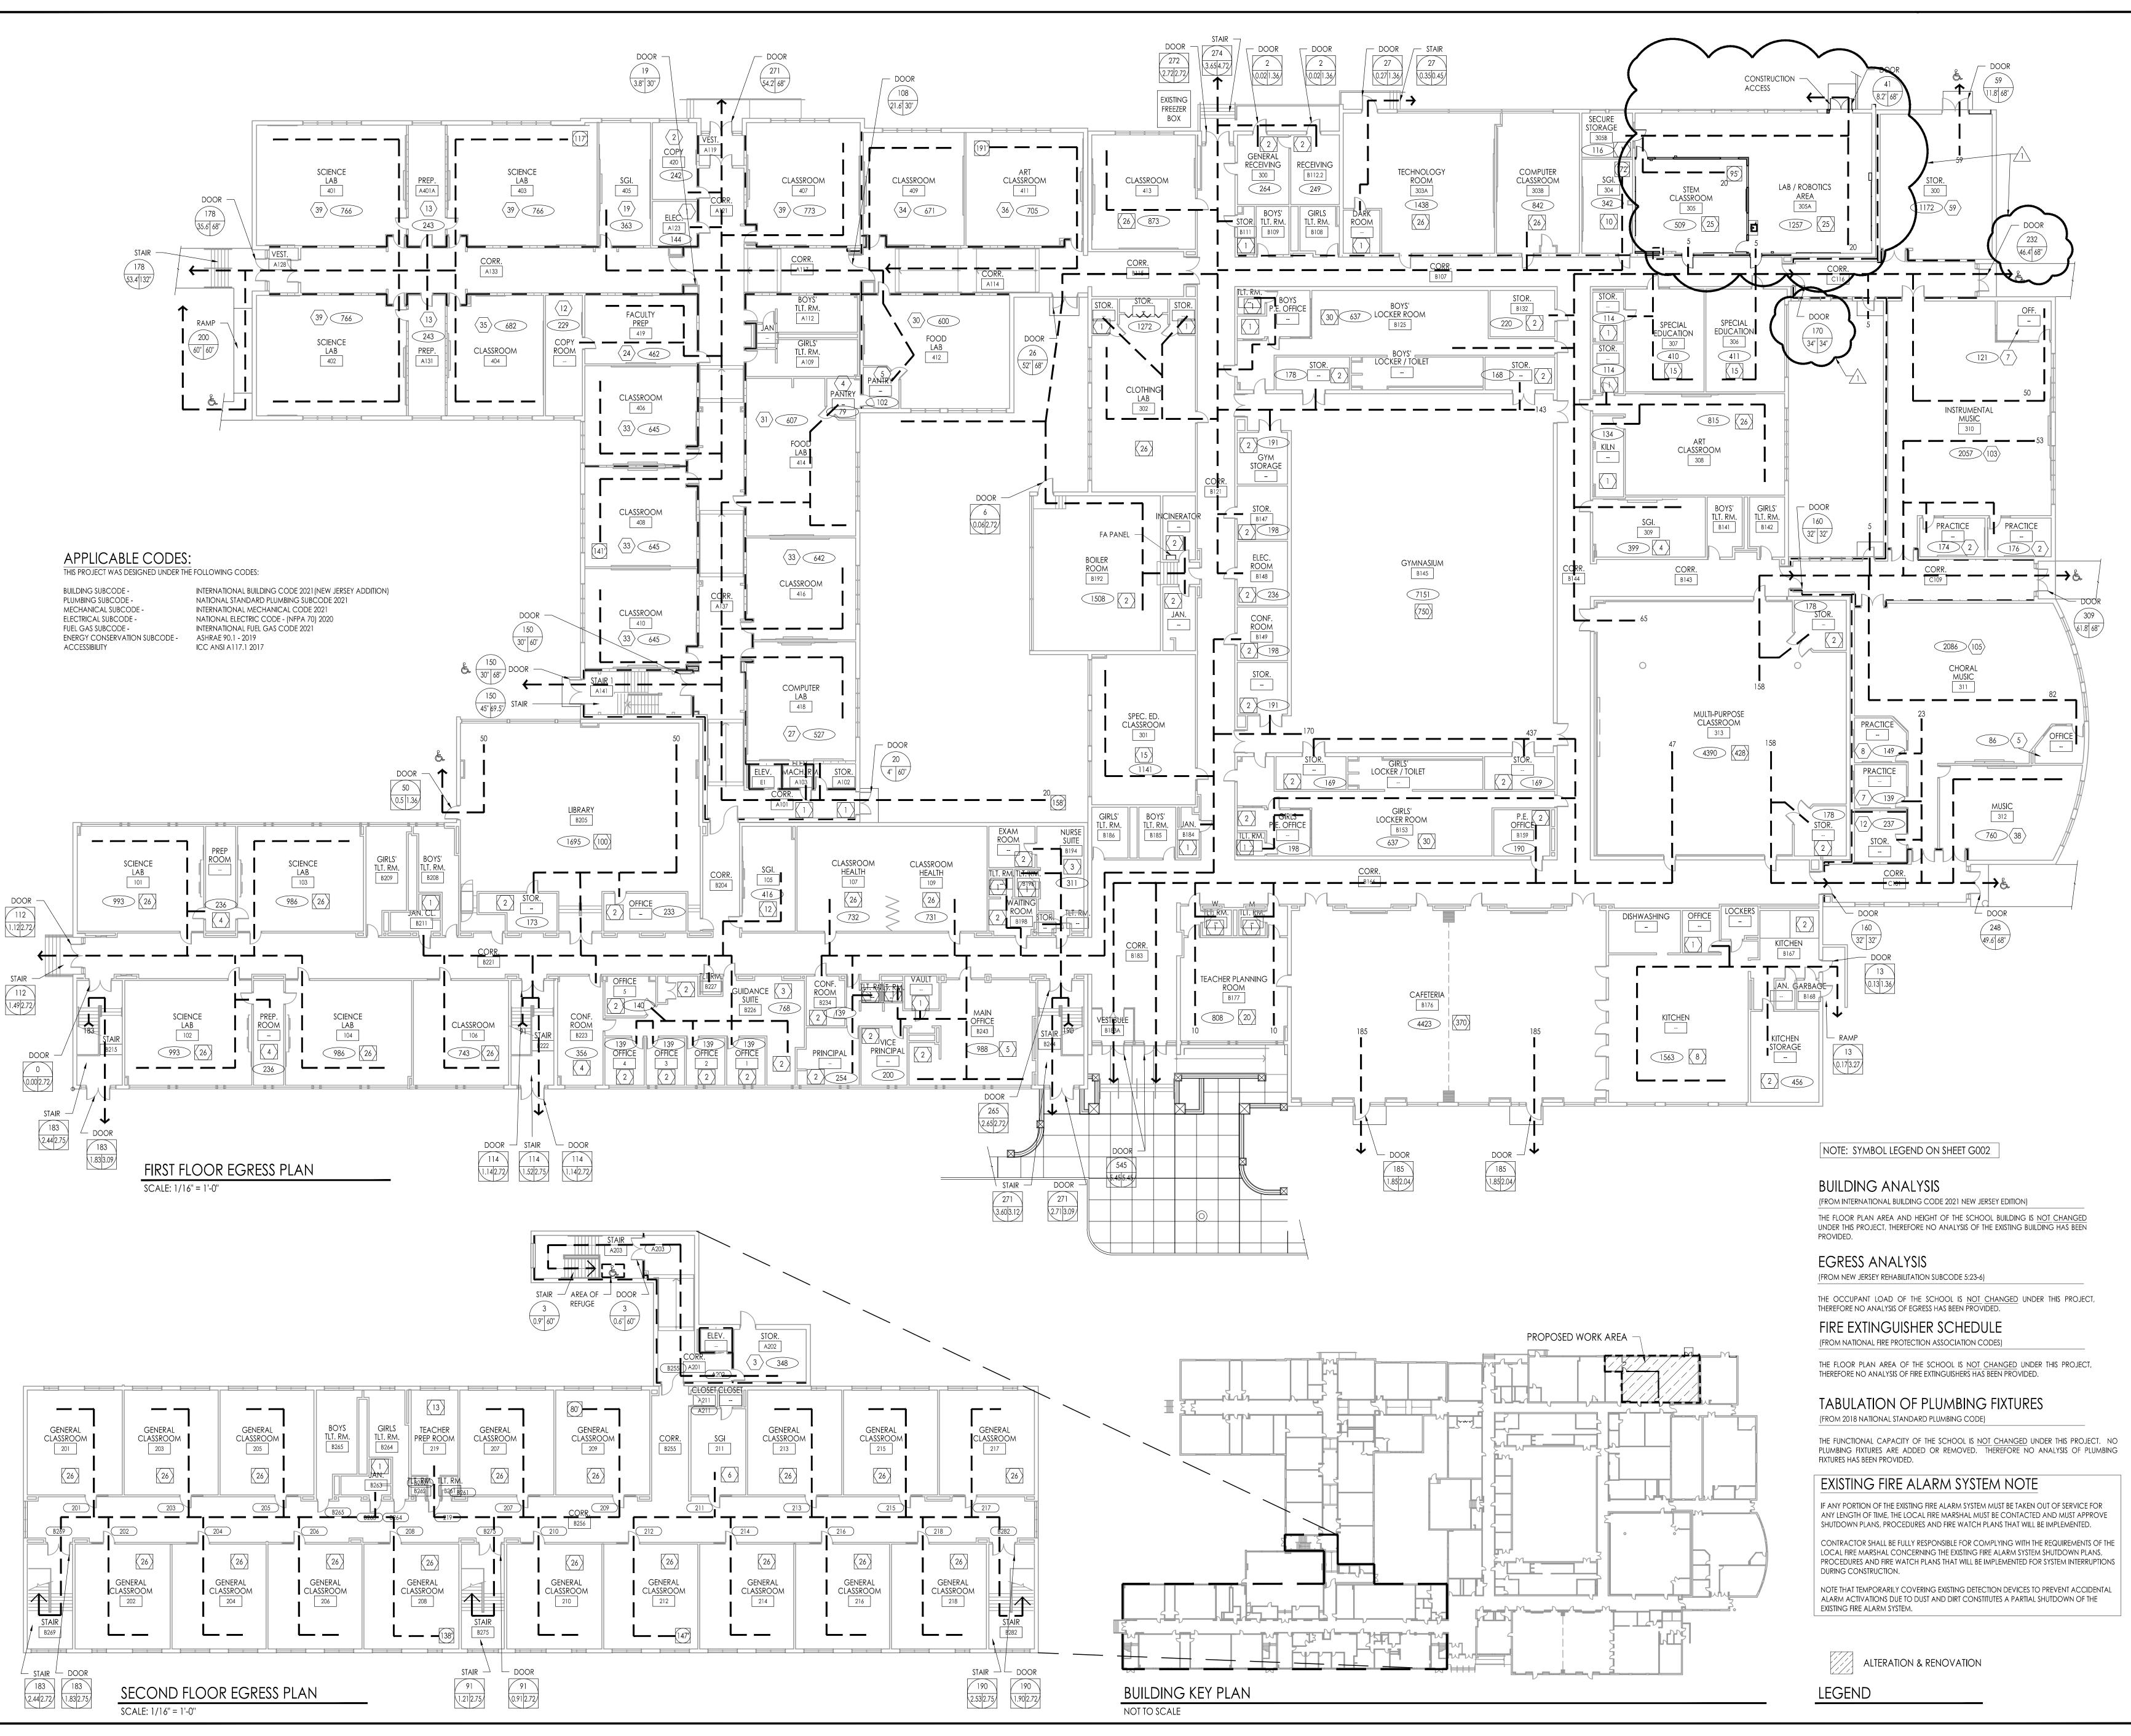

Clearview Regional Middle School

STEM Lab Alterations

& Renovations at

Project Owner Name Clearview Regional High School District

Project Location 595 Jefferson Rd, Mullica Hill, NJ 08062

Project Number 5162C Project Date 10/11/2023 Checked By

GRD Drawn By JMK/SB

Drawing Name

EGRESS PLAN

Scale AS NOTED

No. Date Description

10.20.23 ADDENDUM 1

Drawing Number

GENERAL NOTES ON DEMOLITION: THESE NOTES SHALL APPLY TO ALL DEMOLITION WORK THROUGHOUT THE PROJECT. A. ALL CONTRACTORS ARE ADVISED TO VISIT THE SITE AND VERIFY ALL AREAS AND CONDITIONS PRIOR TO SUBMITTING THEIR BIDS. THE CONTRACTOR MUST NOTIFY THE ARCHITECT OF ANY DISCREPANCIES AND/OR OMISSIONS IN WRITING AT LEAST SEVEN DAYS PRIOR TO THE RECEIPT OF BIDS. FAILURE TO SO NOTIFY THE ARCHITECT INDICATES THAT ANY ADDITIONAL COSTS ASSOCIATED WITH THE DISCREPANCIES AND / OR OMISSIONS ARE INCLUDED IN THE CONTRACTOR'S BID AND THAT NO CHANGE TO THE CONTRACT AMOUNT WILL BE MADE AFTER THE RECEIPT OF BIDS OR THE AWARD OF CONTRACTS. ALL PLUMBING, MECHANICAL OR ELECTRICAL DISCONNECTS SHALL BE MADE BY THE RESPECTIVE TRADES. ALL EQUIPMENT, DEVICES, FIXTURES, ETC. SHALL BE REMOVED FROM THE SITE BY THE RESPECTIVE CONTRACTOR. NOTE: THE EXISTING FIRE ALARM SYSTEM SHALL NOT BE DIMINISHED NOR SHALL EXISTING FIRE ALARM DEVICES BE REMOVED UNTIL NEW DEVICES ARE READY FOR SWITCHOVER. UNLESS NOTED OTHERWISE ALL DEMOLITION MATERIAL SHALL BE REMOVED OFF SITE BY THE CONTRACTOR AT NO ADDITIONAL COST TO THE OWNER. THERE ARE SOME SPECIFIC ITEMS DESIGNATED BY THE ARCHITECT FOR SALVAGE. THESE ITEMS ARE INTENDED FOR REUSE IN THE NEW NEW CONSTRUCTION.

- CONSTRUCTION. THE CONTRACTOR MUST TAKE CARE IN THE REMOVAL AND STORAGE OF THESE ITEMS UNTIL THEY ARE NEEDED IN THE
- E. THE CONTRACTOR SHALL MAKE EVERY EFFORT TO PROTECT PORTIONS OF THE EXISTING CONSTRUCTION WHICH ARE ADJACENT TO AREAS TO BE DEMOLISHED. MAKE ALL CUTS AS NEATLY AS POSSIBLE. REFER TO FLOOR PLAN DRAWINGS FOR FINISHING OF THESE
- IF NOT OTHERWISE NOTED OR DETAILED, ALL SURFACES LEFT ROUGH OR UNFINISHED BY DEMOLITION AND WHICH ARE EXPOSED TO VIEW, SHALL BE PATCHED TO MATCH ADJACENT SURFACES AND FINISHED TO PROVIDE A UNIFORM APPEARANCE WITH REGARD TO SIZE, SHAPE, COLOR, TEXTURE AND MATERIAL.
- THE CONTRACTOR SHALL PROVIDE A PHYSICAL BARRIER TO CONTAIN DUST AND DIRT AROUND THE DEMOLITION AREA AND SHALL MAKE EVERY EFFORT TO KEEP THE DEMOLITION SITE AND SURROUNDING AREAS AS CLEAN AS POSSIBLE. ALL TEMPORARY PARTITIONS SHALL BE 1 HOUR RATED CONSTRUCTION AND INCLUDE A DOOR.
- NO DEMOLITION SHALL BEGIN UNTIL PROPER PROTECTION IS IN PLACE AND APPROVED BY ARCHITECT & OWNER TO ENSURE THE SAFETY OF THE
- PUBLIC, THE BUILDING OCCUPANTS, CONSTRUCTION WORKERS AND TO CONTAIN DUST AND DIRT WITHIN THE AREA OF DEMOLITION. THE CONTRACTOR SHALL COMPLY WITH ALL FEDERAL, STATE AND LOCAL LAWS REGARDING THE REMOVAL AND DISPOSAL OF ALL MATERIALS &
- THE CONTRACTOR SHALL PROVIDE PROTECTION AGAINST INCLEMENT WEATHER FOR THE EXISTING BUILDING DURING THE INTERIM PERIOD BETWEEN DEMOLITION AND THE COMPLETION OF NEW CONSTRUCTION.
- THE CONTRACTORS SHALL TAKE INTO ACCOUNT THEIR METHODS OF CONSTRUCTION FOR THE NEW WORK AND INCLUDE IN THEIR BID THE COST OF ADDITIONAL DEMOLITION WORK NECESSARY TO FACILITATE THE CONSTRUCTION. THIS WORK INCLUDES, BUT IS NOT LIMITED TO THE AREA AROUND JOINTS BETWEEN NEW AND EXISTING CONSTRUCTION IN WALLS, FLOORS AND CEILINGS, AREAS OF SIDEWALK AND PAVING, ETC. MUCH OF THIS
- THE DEMOLITION WORK SHOWN ON THIS PLAN IS INTENDED TO BE A GENERAL OVERVIEW OF MAJOR DEMOLITION WORK REQUIRED. IT IS NOT A COMPLETE AND EXCLUSIVE REPRESENTATION OF ALL DEMOLITION WORK NEEDED FOR EXECUTION OF THE PROJECT. WHEN PREPARING THEIR BIDS, CONTRACTORS MUST REFER TO THE FULL SET OF CONSTRUCTION DOCUMENTS FOR VARIOUS MISCELLANEOUS ITEMS WHICH MUST BE REMOVED AND/OR RELOCATED AS PART OF THE WORK.
- M. CONTRACTORS ARE RESPONSIBLE FOR THEIR OWN CUTTING AND PATCHING SEE SPECIFICATION.

WORK IS INDICATED IN SECTIONS AND DETAILS RELATING TO THE NEW CONSTRUCTION.

- N. THE OWNER HAS THE RIGHT OF FIRST REFUSAL FOR ALL EQUIPMENT AND FIXTURES (CABINETS, SHELVING, ETC.) REMOVED UNDER CONTRACT. IF THE OWNER DOES NOT EXERCISE THIS RIGHT FOR AN INDIVIDUAL PIECE OF EQUIPMENT, THE GENERAL CONTRACTOR SHALL REMOVE SAID EQUIPMENT
- O. GENERAL CONTRACTOR TO RE-CAULK SEALANT AT ALL SOFT GAPS AT EXISTING COLUMNS AND MASONRY WALLS.

DEMOLITION / RENOVATION NOTES:

SEE GENERAL NOTES ON DEMOLITION ON THIS DRAWING. SYMBOL REFERENCE ON DEMOLITION PLAN - $\left\langle \ \ \ \ \right\rangle$

GENERAL NOTE: THE OWNER HAS THE RIGHT OF FIRST REFUSAL FOR ALL EQUIPMENT AND FIXTURES (CABINETS, SHELVING, PLUMBING FIXTURES, ETC.) REMOVED UNDER CONTRACT. IF THE OWNER DOES NOT EXERCISE THIS RIGHT FOR AN INDIVIDUAL PIECE OF EQUIPMENT, THE CONTRACTOR SHALL REMOVE SAID EQUIPMENT FROM THE SITE.

EXTERIOR SITE / BUILDING

- REMOVE EXISTING DOOR AND FRAME IN ITS ENTIRETY. BRACE AND SHORE UP EXISTING CONSTRUCTION TO REMAIN ABOVE OPENING. SAWCUT AND REMOVE EXISTING WALL CONSTRUCTION TO WIDTH AND HEIGHT AS INDICATED ON DEMOLITION PLAN AND TO FIRST MASONRY COURSE ABOVE 8'-0" ABOVE FLOOR. INFILL OPENING WITH NEW ALUMINUM FRAME AND DOOR AND WALL CONSTRUCTION TO MATCH EXISTING AND LINTEL OF THICKNESS TO MATCH EXISTING ADJACENT WALL. SEE FLOOR PLAN AND WALL SECTION. TOOTH-IN NEW BRICK AND CMU INTO EXISTING WALL PATTERN. CONTRACTOR SHALL TAKE ALL NECESSARY STEPS TO ENSURE BUILDING SECURITY AND WEATHERTIGHTNESS. FINISH ALL NEWLY EXPOSED SURFACES AND PATCH AND REPAIR ALL DAMAGE CAUSED BY RENOVATION TO MATCH EXISTING ADJACENT FINISH, INCLUDING TILE, PLASTER, ETC. SEE DOOR SCHEDULE AND DETAILS FOR ADDITIONAL INFORMATION.
- DEMOLISH EXISTING CONCRETE PAD, AND STEP IN ITS ENTIRETY. INSTALL NEW CONCRETE PAD AS SHOWN IN DETAIL 1/A301. MAINTAIN EXISTING FOOTING OF ADJACENT CURB AND BUILDING. PATCH AND REPAIR ALL DAMAGE CAUSED BY DEMOLITION TO MATCH EXISTING ADJACENT FINISH.
- . NOT USED

WALLS

- REMOVE EXISTING DOOR AND ASSOCIATED HARDWARE. PATCH, FILL, CLEAN, PRIME, AND PAINT EXISTING FRAME ON BOTH SIDES, ANY ADJACENT WALL SURFACE DAMAGED DURING DEMOLITION IS TO BE RESTORED TO A UNIFORM, FLUSH, CONTINUOUS SURFACE TO RECEIVE NEW FINISHES. SEE ROOM FINISH SCHEDULE. INSTALL NEW DOOR AND HARDWARE. SEE DOOR AND FRAME SCHEDULE.
- BRACE AND SHORE UP EXISTING CONSTRUCTION TO REMAIN ABOVE OPENING. SAWCUT AND REMOVE EXISTING WALL CONSTRUCTION TO WIDTH INDICATED ON DEMOLITION PLAN AND TO FIRST MASONRY COURSE 8" ABOVE NEW DOOR HEAD HEIGHT. INFILL OPENING WITH NEW DOOR AND FRAME CONSTRUCTION AND LINTEL OF THICKNESS TO MATCH EXISTING ADJACENT WALL, NEW CMU SHALL BE TOOTHED INTO EXISTING ADJACENT CMU. CONSTRUCT WITH 1 HOUR RATED CONSTRUCTION (UL DES U905 OR U906) AT ALL CORRIDOR WALLS. SEE FLOOR PLAN AND DOOR SCHEDULE. FINISH ALL NEWLY EXPOSED SURFACES AND PATCH AND REPAIR ALL DAMAGE CAUSED BY RENOVATION TO MATCH EXISTING ADJACENT FINISH, INCLUDING BRICK, TILE, BASE, ETC. UNLESS SHOWN OTHERWISE ON PLANS.
- REMOVE METAL PANELS FROM FACE OF CMU WALL IN THEIR ENTIRETY. INFILL OPENING IN EXISTING WALL THAT IS NEWLY EXPOSED WITH MATCHING MATERIAL. PATCH ALL ADJACENT SURFACE DAMAGES CAUSED BY DEMOLITION TO MATCH NEW ADJACENT WALL SURFACES.
- FILL ALL HOLES IN THE EXISTING WALLS INCLUDING BUT NOT LIMITED TO THOSE THAT WILL BE EXPOSED AT COMPLETION, BEFORE PREPPING THE SURFACE FOR NEW FINISH.
- REMOVE EXISTING SIGNAGE TAG. PATCH AND REPAIR ANY DAMAGE CAUSED BY REMOVAL. PREPARE SURFACE TO RECEIVE REPLACEMENT OR NEW FINISH TO MATCH SURROUNDING.
- REMOVE RESIDUAL ADHESIVE FROM WALLS AND PATCH TO MATCH SURROUNDING SURFACE PRIOR TO APPLYING NEW FINISH, SEE ROOM FINISH
- . INFILL RATED WALL, INCLUDING BUT NOT LIMITED TO WHERE A HOLE, OPENING, FORMER THRU-WALL CONDUIT ETC. OCCURS WITH MATERIALS TO

MAINTAIN WALL RATING. PATCH AND PREPARE SURFACE FOR NEW FINISH, SEE ROOM FINISH SCHEDULE.

- PREPARE EXISTING PAINTED CONCRETE FLOOR AS REQUIRED BY NEW FLOORING MANUFACTURER. REFER TO ROOM FINISH SCHEDULE FOR NEW
- 2. FLOOR MOUNTED ELECTRICAL "DOGHOUSES" AND FLUSH FLOOR BOXES TO BE REMOVED IN THEIR ENTIRETY. INFILL OPENINGS IN FLOOR WITH CONCRETE FLUSH WITH ADJACENT SURFACES. REFER TO ELECTRICAL DRAWINGS FOR ADDITIONAL INFORMATION.
- 13. NOT USED

EQUIPMENT

- . EXISTING METAL SHELVING UNITS TO BE REMOVED BY OWNER PRIOR TO START OF CONSTRUCTION. REMOVE ALL WALL MOUNTED DEVICES INCLUDING BUT NOT LIMITED TO GOGGLE CABINET, SOAP AND TOWEL DISPENSERS, TACKSTRIPS, ETC. SEE GENERAL NOTE. PATCH, PLUG AND FILL ALL OPENINGS IN AREA OF WORK INCLUDING ADJACENT SURFACE TO RESTORE TO A UNIFORM, FLUSH, CONTINUOUS SURFACE TO RECEIVE NEW FINISHES. SEE ROOM FINISH SCHEDULE.
- REMOVE EXISTING WALL MOUNTED PROJECTOR AND SPEAKERS IN THEIR ENTIRETY. PATCH ALL DAMAGED CAUSED BY DEMOLITION TO MATCH ADJACENT SURFACES. REFER TO ELECTRICAL DRAWINGS FOR ADDITIONAL INFORMATION.
- REMOVE AND STORE EXISTING INTERACTIVE DRY MARKER BOARDS AND ALL APPURTENANCES. RELOCATE PER OWNER'S DISCRETION. PATCH AND REPAIR ANY HOLES LEFT BEHIND FROM INSTALLATION, PREP FOR NEW FINISH. SEE ROOM FINISH SCHEDULE.
- REMOVE "BRAKE-PAC" EQUIPMENT FROM WALL AND HAND OVER TO OWNER. PATCH, REPAIR ANY HOLES LEFT BEHIND FROM INSTALLATION, PREP FOR NEW FINISH. SEE ROOM FINISH SCHEDULE.
- REMOVE EXISTING CHALKBOARDS, EXHIBITION BOARDS AND MIRRORS IN THEIR ENTIRETY. IF WALL IS TO REMAIN, PATCH SUBSTRATE UP TO A MAXIMUM DEPTH OF 4" BEHIND REMOVED ITEMS TO PROVIDE A UNIFORM, FLUSH, CONTINUOUS SURFACE TO RECEIVE NEW FINISHES. SEE ROOM FINISH SCHEDULE. WHERE EXISTING BOARDS ARE RECESSED IN WALL FACE, INSTALL NEW SUPPORT BLOCKING TO SUPPORT NEW BOARDS INSTALLED OVER RECESS. PATCH AND REPAIR ALL DAMAGE CAUSED BY RENOVATION. MATCH TO EXISTING ADJACENT FINISH.
- . REMOVE ALL EXISTING FIRE EXTINGUISHERS AND BRACKETS AND HAND OVER TO OWNER.
- . REMOVE BELL, SPEAKER HORN AND ANALOG CLOCK FROM WALL. PATCH AND FILL OPENINGS FROM REMOVAL. PREP SURFACES TO RECEIVE NEW FINISHES, SEE ROOM FINISH SCHEDULE. HAND OVER ALL REMOVED EQUIPMENT TO OWNER. SEE RESPECTIVE MEP'S DRAWINGS FOR ADDITIONAL REMOVAL INFORMATION.

ELECTRICAL

. NOT USED

22. RE-ESTABLISH NEW LOCATION OF FIRE-ALARM PULL STATION ACCORDING TO MEP'S NEW WORK PLAN ON RESPECTIVE DRAWINGS. AND RELOCATE EXISTING FIRE STROBES AT A HIGHER ELEVATION ON WALL OR IN DIFFERENT LOCATION ACCORDING TO MEP'S RESPECTIVE DRAWINGS. SEE

MISCELLANEOUS

23. SEE MEP DRAWINGS FOR ADDITIONAL DEMOLITION REQUIREMENTS.

EXISTING FIRE ALARM SYSTEM NOTE

INTERRUPTIONS DURING CONSTRUCTION.

"EXISTING FIRE ALARM SYSTEM NOTE".

IF ANY PORTION OF THE EXISTING FIRE ALARM SYSTEM MUST BE TAKEN OUT OF SERVICE FOR ANY LENGTH OF TIME, THE LOCAL FIRE MARSHAL MUST BE CONTACTED AND MUST APPROVE SHUTDOWN PLANS, PROCEDURES AND FIRE WATCH PLANS THAT WILL BE IMPLEMENTED. CONTRACTOR SHALL BE FULLY RESPONSIBLE FOR COMPLYING WITH THE REQUIREMENTS OF THE LOCAL FIRE MARSHAL CONCERNING THE EXISTING FIRE ALARM SYSTEM SHUTDOWN PLANS, PROCEDURES AND FIRE WATCH PLANS THAT WILL BE IMPLEMENTED FOR SYSTEM

NOTE THAT TEMPORARILY COVERING EXISTING DETECTION DEVICES TO PREVENT ACCIDENTAL ALARM ACTIVATIONS DUE TO DUST AND DIRT CONSTITUTES A PARTIAL SHUTDOWN OF THE EXISTING FIRE ALARM SYSTEM.

GENERAL CONSTRUCTION NOTES:

THESE NOTES SHALL APPLY TO ALL WORK THROUGHOUT THE PROJECT

- A. ALL CONTRACTORS SHALL VISIT THE SITE AND VERIFY ALL EXISTING CONDITIONS BEFORE SUBMITTING A BID. DISCREPANCIES OR OMISSIONS MU\$T . ALL CORRIDOR WALLS ARE 1HR RATED, AS PER UL DES #U905/U906 U.N.O BE REPORTED TO THE ARCHITECT IN WRITING (15) DAYS PRIOR TO BID OPENING. IF HE OR SHE DOES NOT, CONTRACTOR SHALL CORRECT SAME 🔪 AT NO CHANGE IN CONTRACT PRICE.
- 3. CONTRACTOR IS RESPONSIBLE FOR ALL MEANS AND METHODS OF CONSTRUCTION. CONTRACTOR SHALL PROVIDE ALL REQUIRED SAFETY PROTECTION DURING CONSTRUCTION.
- C. IT SHALL BE THE CONTRACTOR'S RESPONSIBILITY TO PROVIDE A SUFFICIENT WORK FORCE TO MEET COMPLETION DATES AS OUTLINED IN THE
- SPECIFICATIONS. NO EXCEPTIONS WILL BE ALLOWED.
- D. CONTRACTOR SHALL PROVIDE ALL REQUIRED SAFETY PROTECTION DURING CONSTRUCTION.
- E. DO NOT SCALE THE DRAWINGS.
- F. DETAILS NOTED "TYPICAL" IMPLY ALL SUCH CONDITIONS BE TREATED SIMILARLY.
- G. ALL WORK PERTAINING TO THESE DRAWINGS SHALL BE PERFORMED IN ACCORDANCE WITH ALL APPLICABLE STATE AND LOCAL CODES AND IN AGREEMENT WITH ALL AGENCIES HAVING JURISDICTION.
- H. THE CONTRACTOR IS RESPONSIBLE TO SECURE ALL PERMITS, TO OBTAIN APPROVALS AS REQUIRED AND COORDINATE INSPECTION WITH LOCAL. BUILDING INSPECTOR. ALL PERMIT AND APPLICATION FEES WILL BE PAID BY THE OWNER AND DELIVERED BY THE CONTRACTOR.
- DRAWINGS AND SPECIFICATIONS COMPLEMENT EACH OTHER. WORK NOT SHOWN ON DRAWING BUT CALLED FOR IN THE SPECIFICATIONS IS STILL REQUIRED. AND ALL WORK NOT CALLED FOR IN SPECIFICATIONS, BUT CALLED OUT OR SHOWN IN DRAWINGS IS STILL REQUIRED.
- J. UNLESS OTHERWISE NOTED AND UNLESS FACTORY FINISHED, ALL EXPOSED SURFACES OF CMU, CONCRETE, PLASTER, WOOD, GYPSUM BOARD, HOLLOW METAL, HARDWOODS, MISCELLANEOUS METALS ETC., ARE TO RECEIVE PRIME AND FINISH COATS OF PAINT OR CLEAR FINISH AS SPECIFIED AND IN COLORS AS SELECTED BY ARCHITECT. EXCLUDED FROM THIS IS BRICK.
- K. MATERIALS LISTED ON THE ROOM FINISH SCHEDULE REFER TO THE MAJORITY OF WALLS, FLOOR AND CEILING OF ROOMS SCHEDULED. REFER T PLANS, DETAILS, INTERIOR ELEVATIONS, CEILING PLANS AND NOTES FOR MATERIALS NOT INDICATED ON THE SCHEDULE BUT ARE STILL REQUIRED
- THE OWNER WILL REMOVE AND RE-INSTALL ALL MOVEABLE EQUIPMENT. EACH CONTRACTOR IS RESPONSIBLE TO REMOVE, STORE AND RE-INSTALL EXISTING BUILT-IN EQUIPMENT REQUIRED TO PERFORM THEIR WORK UNLESS NOTED OTHERWISE
- M. CALL BEFORE YOU DIG. BEFORE DIGGING CONTRACTOR SHALL CALL 1-800-242-1776 TO HAVE UTILITIES IDENTIFY UNDERGROUND LOCATION O ALL SERVICE LINES.
- N. ALL OUTSIDE CORNERS OF INTERIOR CONCRETE MASONRY UNITS (CMU) ARE TO BE BULLNOSED UNLESS NOTED OTHERWISE.

O. ALL BLOCKING FOR THE PROJECT SHALL BE FIRE RETARDANT TREATED WOOD BLOCKING, UNLESS OTHERWISE NOTED.

UNDERSIDE OF -**UNDERSIDE OF** STRUCTURE STRUCTURE ABOVE -CONTINUOUS METAL PROVIDE SOUND TRACK ATTENUATION AT CAVITY EXISTING WALL & FLUTED DECK CONSTRUCTION TO ႕ — — — — — -METAL STUD ANCHOR CONTINUOUS TOP -BRACED TO TRACK - BRACE TO UNDERSIDE OF METAL WALL AT BOTH ENDS DECK OR STRUCTURE AT 32" O.C. RUN STUD WALL TO UNDERSIDE OF CEILING LINE CONSTRUCTION ABOVE -TERMINATI **RUN GYPSUM WALL 6"** IN LONG LEG DEFLECTION MIN. ABOVE CEILING LINE TRACK AND PROVIDE CONTINUOUS BRIDGING BAR (TYP) SEE ROOM FINISH SEE ROOM FINISH SCHEDULE (TYP.) SCHEDULE (TYP.) PROVIDE BLOCKING 5/8" IMPACT RESISTANT GWB 5/8" GWB 6" MTL STUD AT 16" O.C. 3-5/8" MTL STUD AT -SOUND ATTENUATION BATT 24" O.C. TO FULL DEPTH OF MTL STUD BASE - SEE FINISH SCHEDULE FLOOR TRACK FLOOR TRACK -SOUND SEALANT BOTH SIDES SEALANT -**DEMOLITION PLAN** 2 GWB CHASE WALL PARTITION 1 SCALE: 1/8" = 1'-0"

REFLECTED CEILING GENERAL NOTES

- 1. SEE HVAC, PLUMBING AND ELECTRICAL DRAWINGS FOR TYPES, SIZES AND ADDITIONAL INFORMATION ON CEILING-MOUNTED DEVICES.
- 2. ALL DIFFUSERS, DEVICES AND LIGHTS ARE SHOWN IN THE ACB CEILING UNLESS NOTED OTHERWISE
- 3. GENERAL, HVAC, PLUMBING AND ELECTRICAL CONTRACTORS TO COORDINATE LOCATION OF DIFFUSERS, DEVICES AND LIGHTS.
- 4. FOR CEILING HEIGHTS SEE REFLECTED CEILING PLAN.

REFLECTED CEILING CONSTRUCTION NOTES:

SYMBOL REFERENCE ON CEILING PLAN - (χ)


FIXTURES

- LOCATION OF SHADE POCKETS FOR THE ELECTRICAL ROLLER SHADE. THE GRID TRIM WILL MOLD AROUND THE POCKETS WHERE APPLICABLE. SEE DETAIL A/A601 FOR ADDITIONAL DETAIL FOR PLACEMENT OF SHADE POCKET.
- 2. SECTION OF CEILING GRID TO SLOPE UP 45° TOWARDS THE EXTERIOR WINDOWS. SEE SECTION DETAIL 3/A301.
- 3. ROOF METAL DUCT FOR NEW SPRAY BOOTH DISCHARGE TO BE CENTERED IN PANEL. REFER TO ROOF PLAN FOR VENTILATION DETAIL THROUGH EXISTING ROOF
- 4. TYPICAL PVC VENT PIPE TO VENT FLAMMABLE STORAGE UNIT. SEE DETAILS ON ROOF PLAN SHEET A103 FOR ROOF PENETRATION.

DECK AND SEE SPEC. AND MEP DRAWINGS FOR MORE DETAILS.

EXISTING FRAMES TO REMAIN FOR SUPPORTING NEW LED PENDANT LIGHT

REFLECTED CEILING PLAN LEGEND

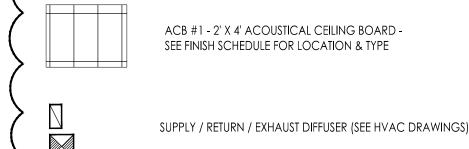

LED LIGHT PANEL (SEE ELECTRICAL DRAWINGS)

LED LIGHT PENDANT (SEE ELECTRICAL DRAWINGS)

POWER POLE (SEE ELECTRICAL DRAWINGS)

REFLECTED CEILING PLAN

SCALE: 1/8" = 1'-0"

ALL WALLS SHALL EXTEND TO UNDERSIDE OF STEEL DECK UNLESS NOTED OTHER WISE. NEW FIRE EXTINGUISHER ON BRACKET (FE-1). SEE ROOM LAYOUT - SHEET A401 FOR LOCATION.

STORAGE LAB / ROBOTICS 30'-6" SEE SHEET A401 FOR ENLARGED FLOOR CLASSROOM SEE SHEET A401 FOR ENLARGED FLOOR

NEW WORK PLAN SCALE: 1/8" = 1'-0"

NOT TO SCALE

PROPOSED WORK AREA

BUILDING KEY PLAN

STEM Lab Alterations & Renovations at Clearview Regional Middle School

roject Owner Name Clearview Regional High School District

Project Location 595 Jefferson Rd, Mullica Hill, NJ 08062

Project Number 5162C Project Date

JMK/SB Scale AS NOTED


Checked By

Drawn By

Drawing Name DEMOLITION, FLOOR & REFLECTED CEILING PLANS, WALL PARTIT-ION TYPES AND NOTE

No. Date Description ↑ 10.20.23 ADDENDUM 1

Drawing Number

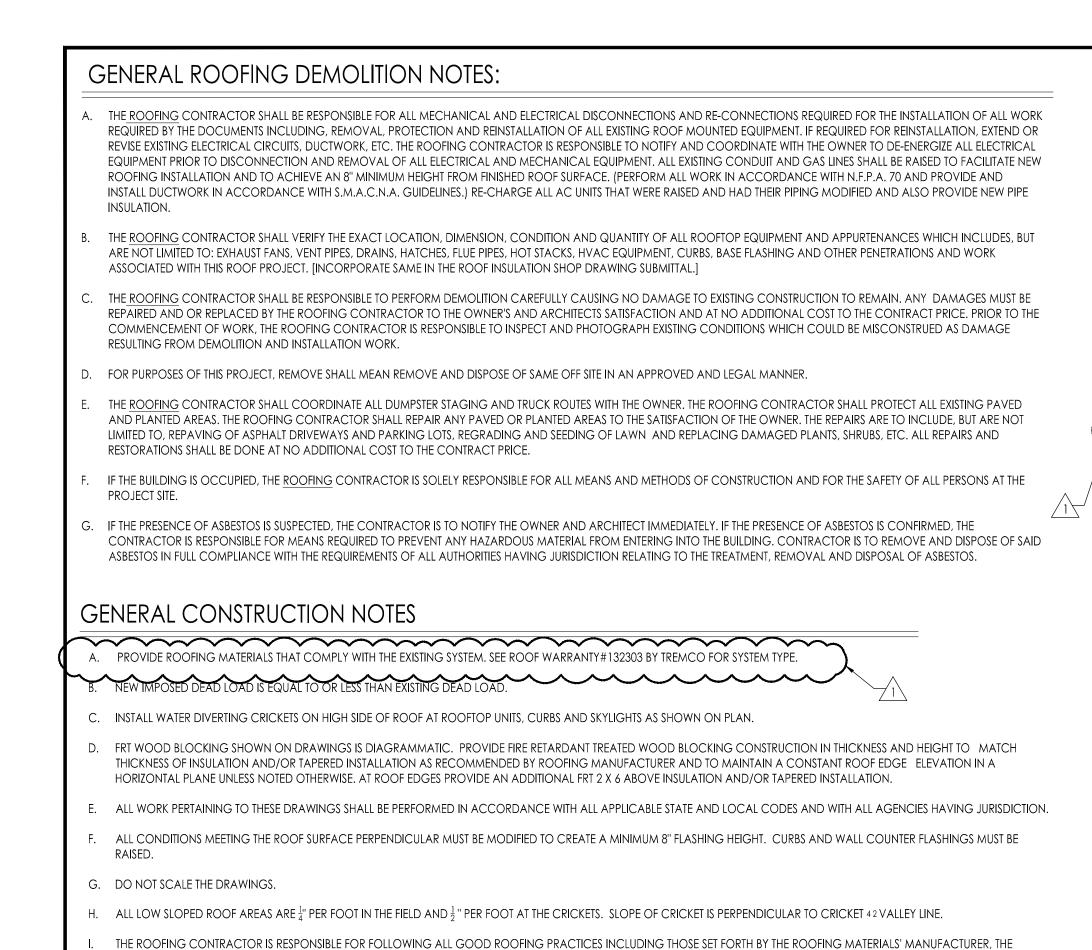

SMACNA SHEET METAL MANUAL, FACTORY MUTUAL, UNDERWRITERS LABORATORIES, AND THE NRCA'S ROOFING AND WATERPROOFING MANUAL.

ADJUSTMENTS MADE BY THE ROOFING CONTRACTOR TO THE INDICATED DESIGN GUIDELINES ARE AT NO ADDITIONAL COST TO THE OWNER.

MANUFACTURER'S WARRANTY. REVIEW ALL DRAWINGS INCLUDED IN THIS SET FOR ROOFTOP PENETRATIONS.

UNLESS NOTED OTHERWISE ALL ROOFING, ACCESSORIES, MATERIALS, ETC. SHALL BE CONSIDERED NEW.

N. ROOFING CONTRACTOR SHALL RETAIN A LICENSED ELECTRICAL SUBCONTRACTOR FOR ALL ELECTRICAL WORK.

2.INSTALL ENVELOPE EDGES TO ELIMINATE THE POTENTIAL FOR BITUMEN AND ADHESIVE DRIPPAGE INTO THE BUILDING

. CONTRACTOR SHALL AT ALL TIMES HAVE A FULL SET OF DRAWINGS AND SPECIFICATIONS ON ROOF TOP WHILE WORK IS IN PROGRESS.

U. CONTRACTOR RESPONSIBLE TO RECTIFY ANY PONDING WATER ON FINISHED ROOF SURFACE THAT REMAINS AFTER 48 HOURS AT NO ADDITIONAL COST

ROOFING CONTRACTOR SHALL RETAIN A LICENSED HVAC SUBCONTRACTOR FOR ALL HVAC WORK.

P. 1. PRIME ALL SURFACES WHICH ARE TO RECEIVE BITUMINOUS ROOFING.

3.ALL WOOD BLOCKING TO BE FRT, (FIRE RETARDANT LUMBER).

ORIGINAL WARRANTY ON EXISTING ROOF.


AND SCUPPERS.

THE ROOFING CONTRACTOR IS RESPONSIBLE FOR FLASHING ALL ROOF TOP PENETRATIONS, UNITS, AND CURBS ON THE ROOFS TO A WATERTIGHT CONDITION TO BE INCLUDED IN THE

ALL CRICKETS/ GUSSETS/ SADDLES SHALL HAVE A 3:5 RATIO. WHERE THIS CONDITION CANNOT BE ACHIEVED DUE TO VALLEY LINE OF CRICKET INTERSECTING MECHANICAL EQUIPMENT, PENETRATION AND A HIGH POINT GREATER THAN THE THRU-WALL COUNTER FLASHING, PROVIDE MAXIMUM CRICKET WIDTH TO PROMOTE POSITIVE DRAINAGE TO ALL ROOF DRAINS

1. HIGH POINTS INDICATED ON DRAWINGS ARE SHOWN FOR GUIDANCE ONLY. THE ROOFING CONTRACTOR IS RESPONSIBLE FOR FINAL TAPERED INSULATION DESIGN. ANY REQUIRED

CONTRACTOR SHALL MAKE NECESSARY TIE-INS AND ALTERATIONS TO EXISTING ROOF IN ACCORDANCE WITH ORIGINAL ROOF MANUFACTURERS REQUIREMENTS, SO AS TO MAINTAIN

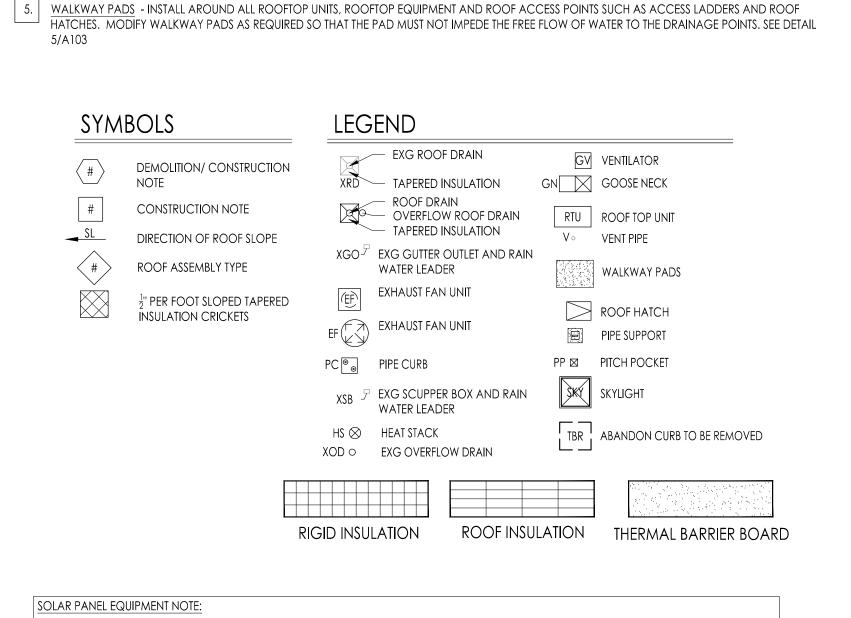

THE EXISTING SOLAR EQUIPMENT IS CURRENTLY OWNED BY THE SCHOOL DISTRICT AND NON-OPERATIONAL. THE GC IS TO REMOVE THE PANELS

. angle remove existing equipment, cap existing curb to remain. See mep drawings for additional notes and details

ACCORDING TO ROOFING MANUFACTURER.

CONSTRUCTION NOTES - SBS: X

PERPENDICULAR TO SADDLE/CRICKET VALLEY LINE. ALL COLORS ARE SELECTED BY ARCH.

MANUFACTURES REQUIREMENTS TO MAINTAIN SAID WARRANTY, TYPICAL.

AND ASSOCIATED EQUIPMENT WITH CARE AND HAND OVER TO THE OWNER.

2. MODIFY EXISTING OPENING OF GRAVITY VENT TO ACCOMMODATE NEW EQUIPMENT. THE CONTRACTOR IS TO TAKE ALL NECESSARY STEPS TO ENSURE

TO PATCH AND REPAIR ALL DAMAGES INCURRED BY THE REMOVAL OF THE SOLAR PANELS ACCORDING TO THE ROOFING MANUFACTURER.

🗸 3. 🔪 de-energize, uninstall panels and associated conduits and appurtenances as shown on drawing outlined. Contractor shall determine

WEATHERTIGHTNESS DURING THE COURSE OF THE WORK. PATCH AND REPAIR ALL DAMAGE CAUSED BY RENOVATION TO MATCH EXISTING ADJACENT SURFACES

WHICH SECTION OF THE PANELS ARE TO BE REMOVED WITH OWNER BEFORE ANY REMOVAL AND THEN HAND OVER ALL EQUIPMENT TO OWNER. CONTRACTOR IS

AT VENT PIPES, INSTALL LIQUID APPLIED FLASHING SYSTEM W/ FLEECE REINFORCING. INSTALL PER MANUFACTURES LATEST INSTALLATION GUIDELINES FLASHING

SHALL BE INCLUDED IN ROOF MANUFACTURES WARRANTY SEE DETAIL 3/ A103. MODIFY/EXTEND ANY VENT PIPES THAT DO NOT MEET THE 8" MINIMUM BASE

AT ALL ROOFTOP EQUIPMENT ON FULLY ENCLOSED CURBS, ROOF HATCHES, & SKYLIGHTS, INSTALL ON WOOD BLOCKING WHICH HAS BEEN FASTENED TO THE

ROOF DECK TO MAINTAIN 8" MINIMUM FLASHING HEIGHT FROM THE SURFACE OF THE ROOF. INSTALL INSULATION AND CANT STRIP. RUN ROOF MEMBRANE UP

CURBS 2" ABOVE THE CANT STRIP. INSTALL SBS MODIFIED BITUMEN BASE FLASHING. FASTEN TOP EDGE AND INSTALL A REMOVABLE COUNTER FLASHING, SEE


DETAIL 2/A 103 AND FOLLOW MFR'S LATEST INSTALLATION REQUIREMENTS. CURBS MUST ALSO BE SET LEVEL WHERE REQUIRED FOR PROPER FUNCTIONING OF

THE ROOF TOP UNIT. PROVIDE 1/2" PER FOOT SLOPED TAPERED INSULATION CRICKETS AT HIGH SIDE OF NEW ROOFTOP EQUIPMENT. CRICKET SLOPE IS

4. EXG ROOF TO REMAIN ARE UNDER WARRANTY, INSTALLATION OF ROOFTOP EQUIPMENT IN THIS AREA SHALL BE DONE IN ACCORDANCE WITH THE ROOFING


AT ALL REMOVED EQUIPMENT THAT WILL EXPOSE THE UNDERSIDE (INTERIOR), CAP EXISTING CURB AS SHOWN ON MEP'S DETAIL 3/H501.


--- ELASHING-HEIGHT

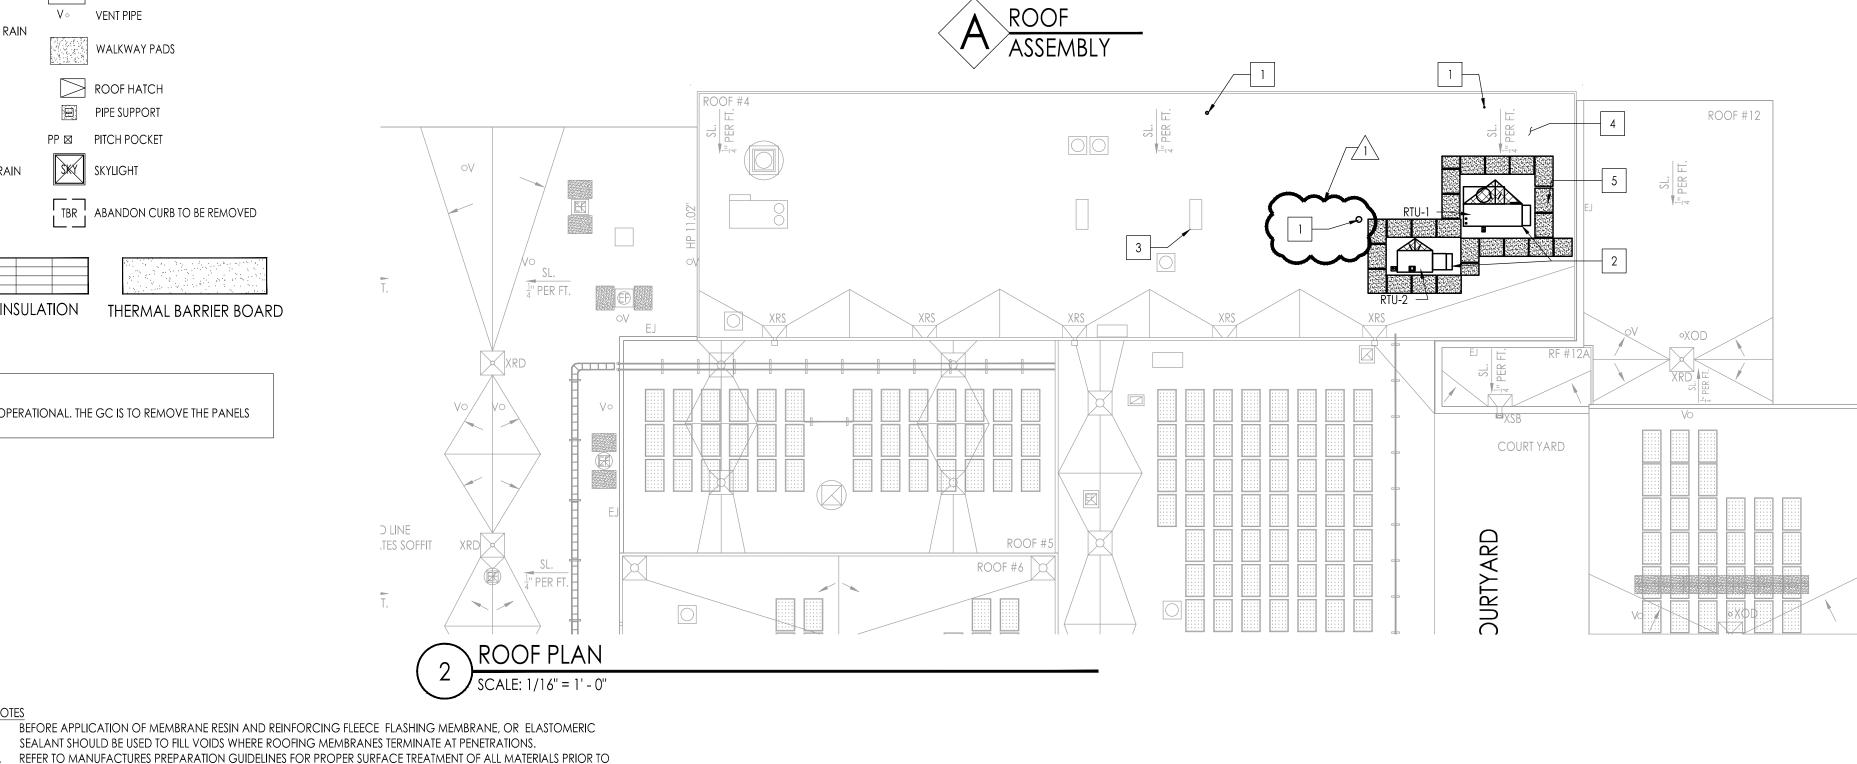

ROOF #5


ROOF #6

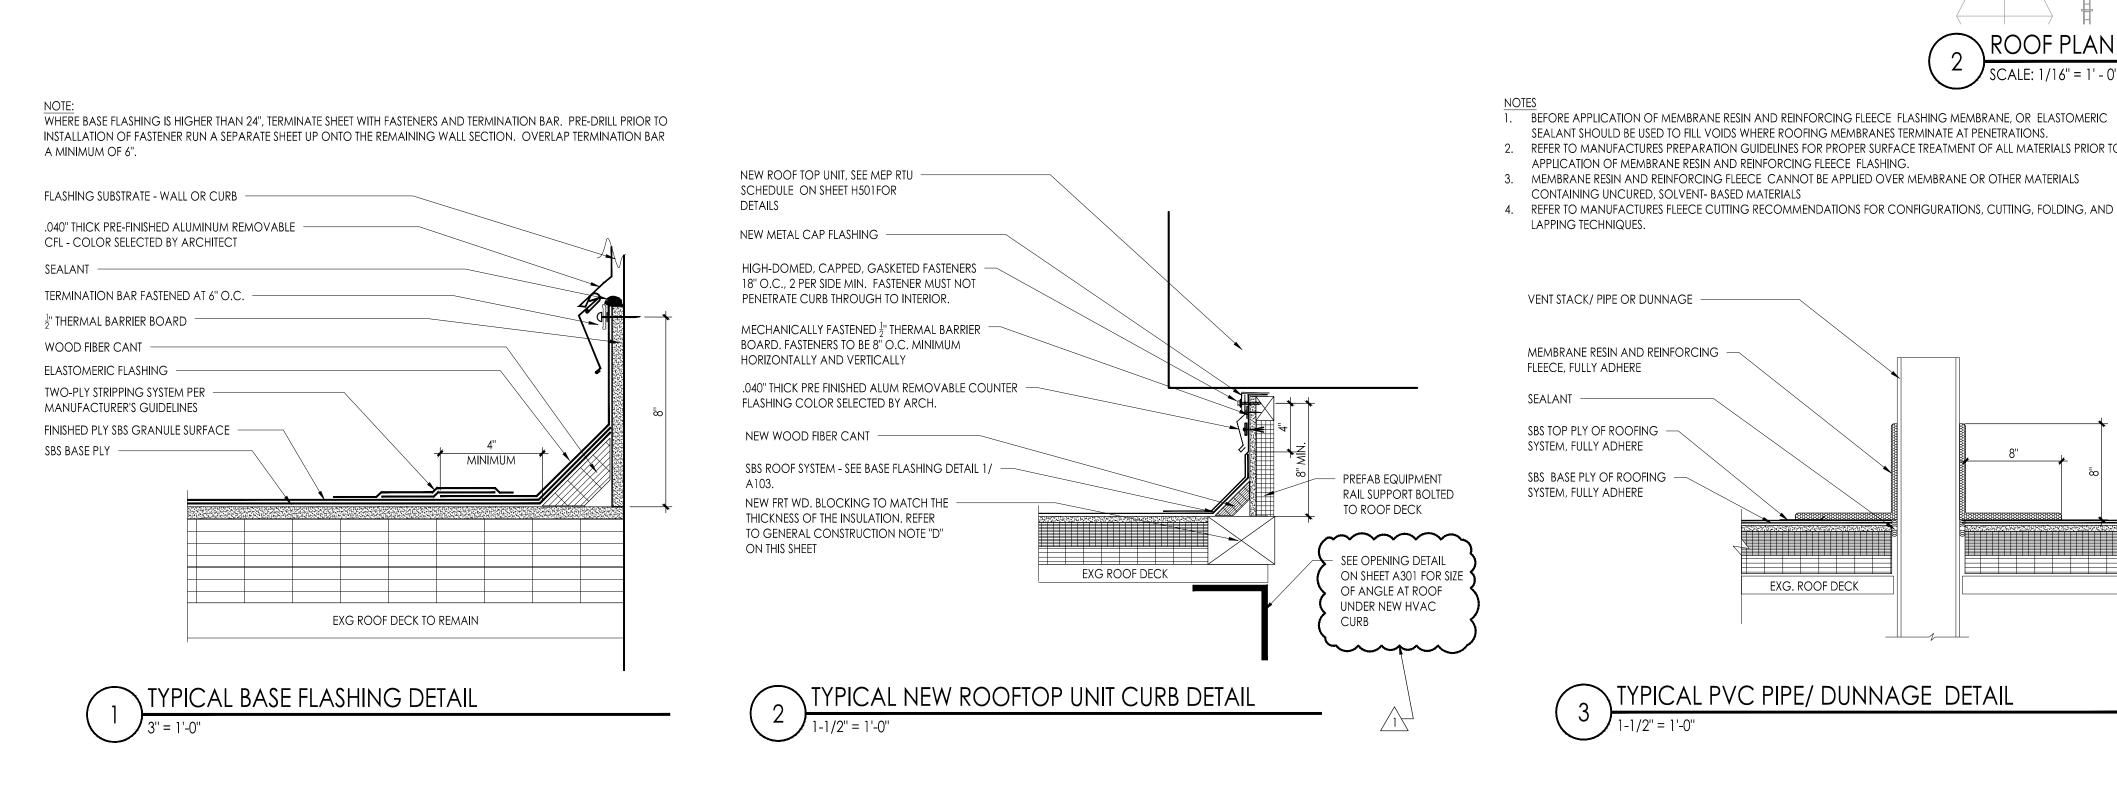


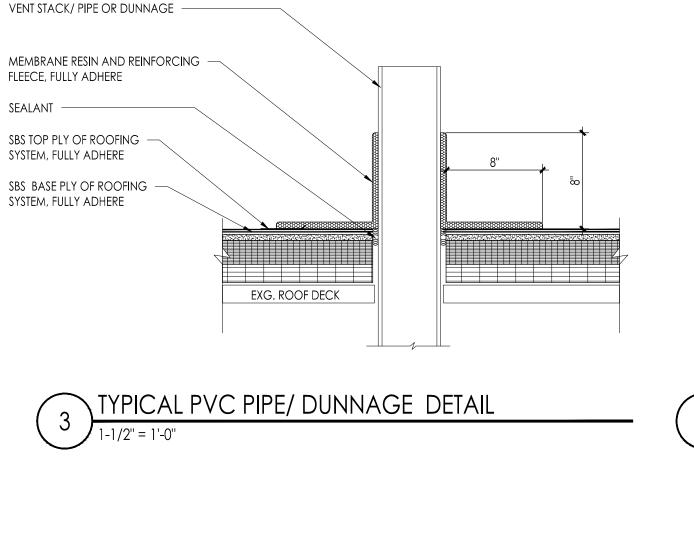

ATES SOFFIT

ROOF PLAN DEMOLITION

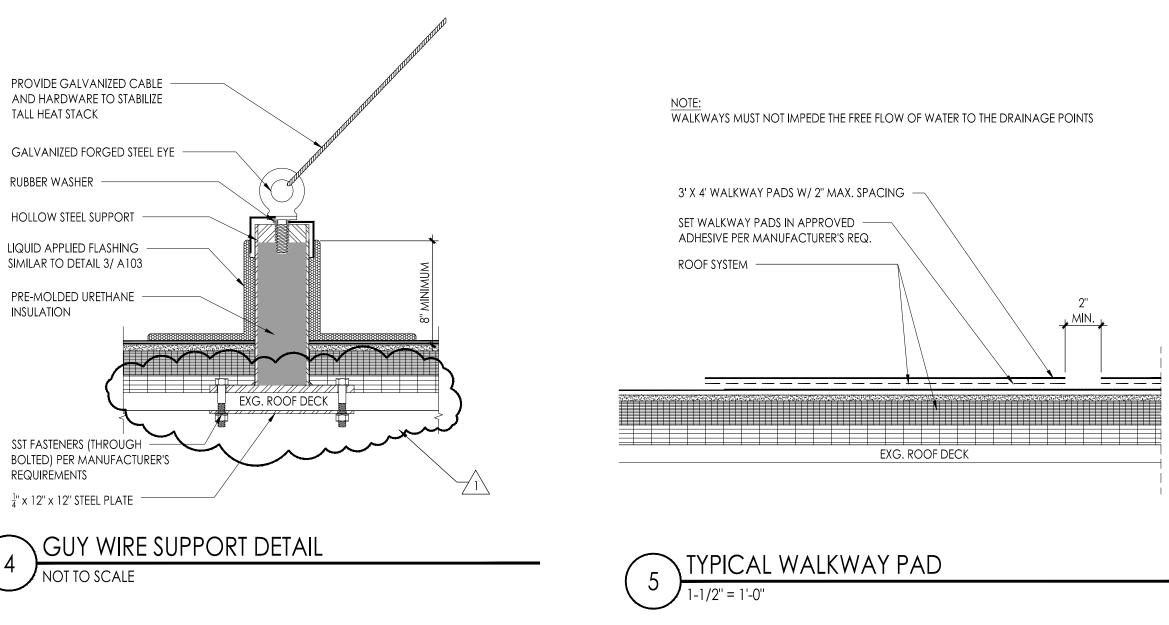

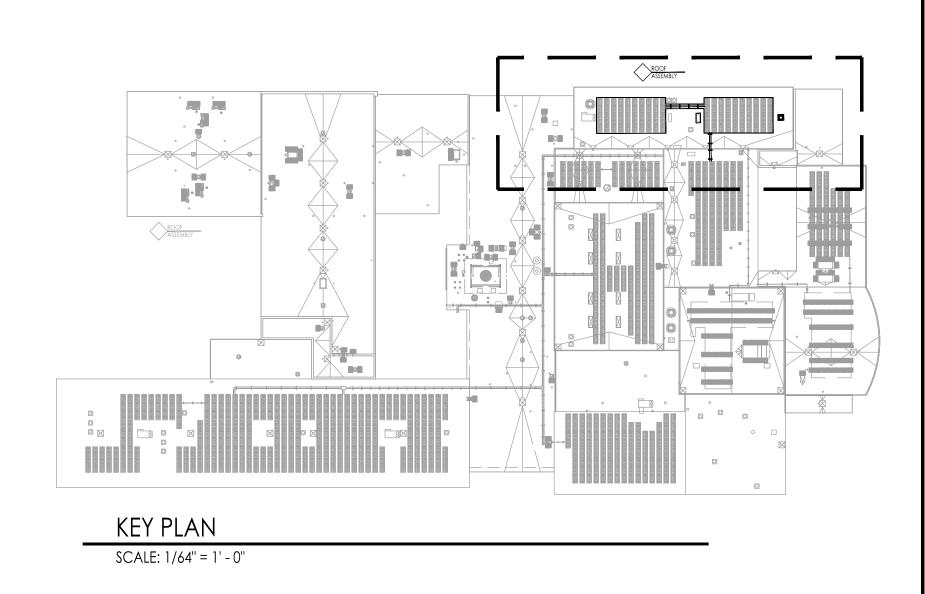

ROOF #12

STEM Lab Alterations & Renovations at Clearview Regional Middle School

Project Owner Name Clearview Regional High School District

Project Location 595 Jefferson Rd, Mullica Hill, NJ

08062

Project Number 5162C Project Date Checked By Drawn By


Scale **AS NOTED**

Drawing Name ROOF PLAN, DETAILS,

AND NOTES

No. Date Description 10.20.23 ADDENDUM 1

Drawing Number

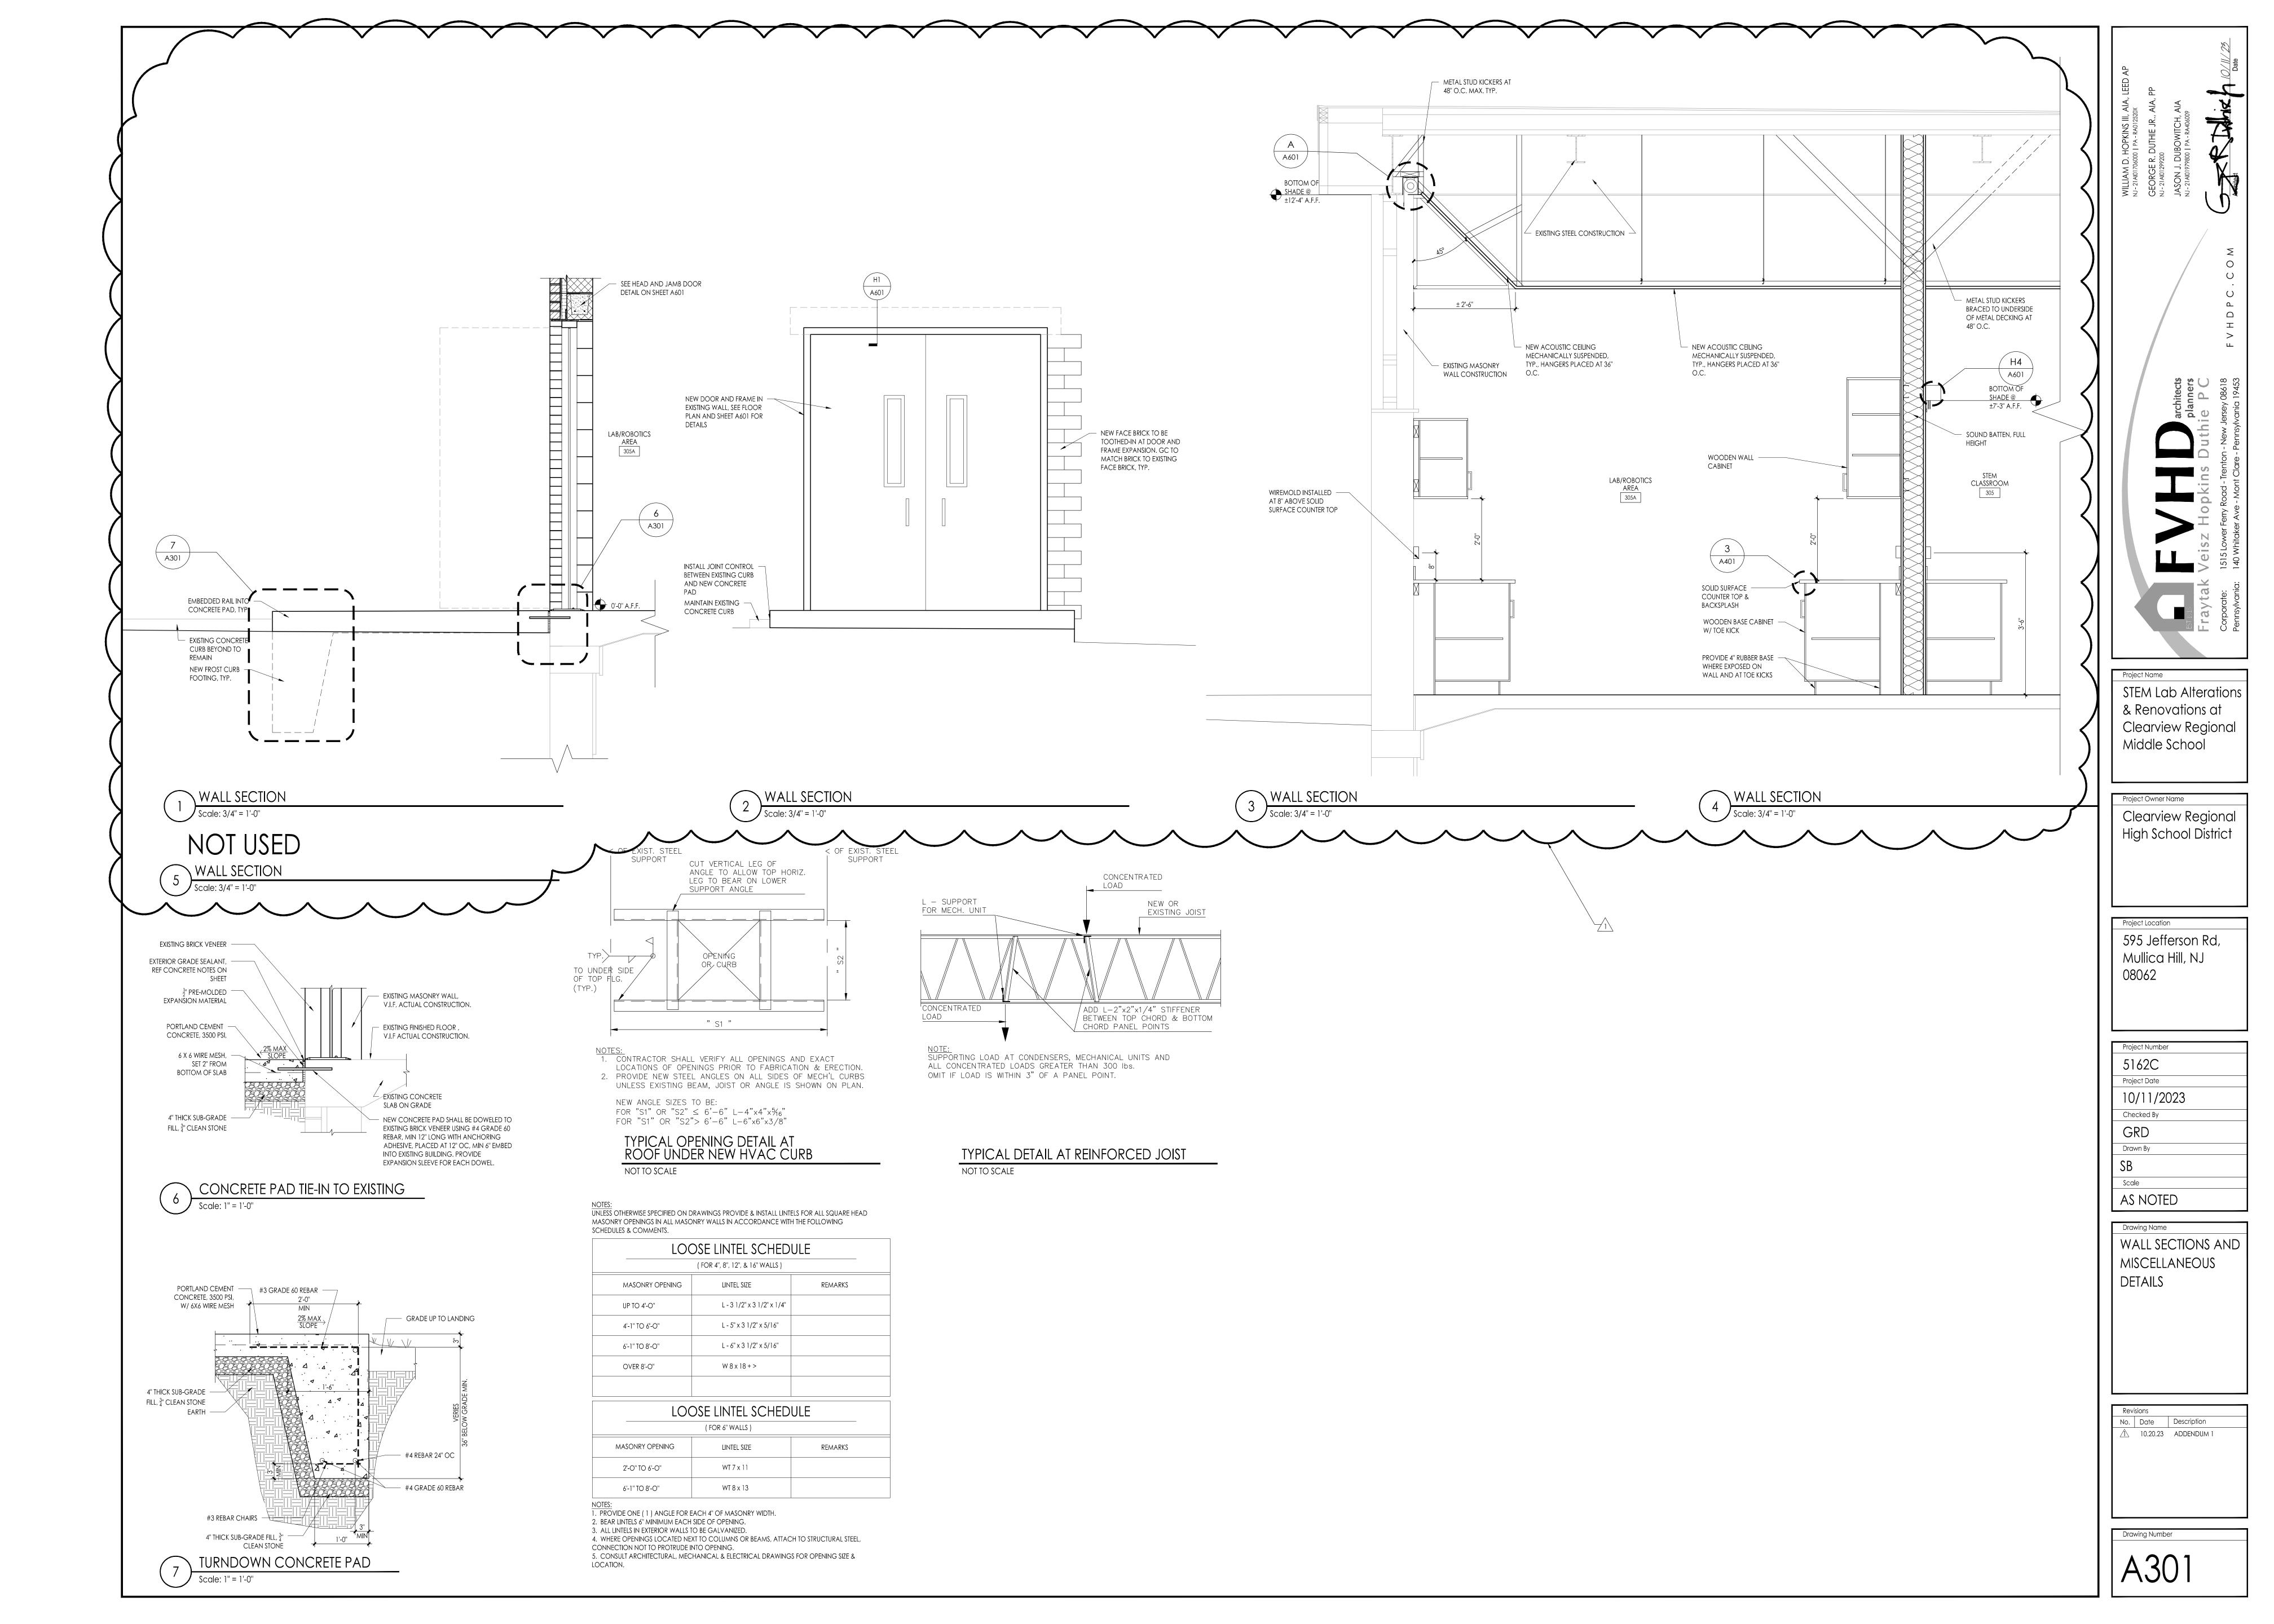


GENERAL CASEWORK NOTES:

- 1. CATALOG NUMBERS REFER TO MOST CURRENT CAMPBELL RHEA CASEWORK CATALOG UNLESS OTHERWISE NOTED. FOR REFERENCE ONLY.
- 2. ALL CASEWORK DOORS AND DRAWERS TO HAVE LOCKS KEYED ALIKE PER ROOM AND MASTER KEYED. 3. ALL TOPS SHALL HAVE PLYWOOD AND SOLID SURFACE COVERING ON ALL EXPOSED SURFACES (UNLESS NOTED OTHERWISE). SEE EDGE DETAILS ON
- SHEET FOR SPECIFIC THICKNESS. 4. ALL BACKSPLASHES SHALL BE 1/2" SOLID SURFACES (UNLESS NOTED
- 5. ALL FURNITURE AND EQUIPMENT SHOWN DOTTED AND/OR INDICATED AS (N.I.C.) IS NOT IN CONTRACT. 6. THE CASEWORK & EQUIPMENT SUB-CONTRACTOR(S) SHALL TURN OVER TO THE PLUMBING AND ELECTRICAL GENERAL CONTRACTOR IN A PACKAGE, ALL SINKS, FIXTURES, FAUCETS, TAILPIECES, STRAINERS, GAS COCKS, ETC.,
- INSTALLATION AND FINAL CONNECTION. 7. THE CASEWORK AND EQUIPMENT SUB-CONTRACTOR SHALL PROVIDE AN ITEMIZED LIST AND A DESIGNATED SITE LOCATION FOR THE TRANSFER OF THE MATERIALS REFERENCED IN NOTE 6 TO THE PLUMBING AND ELECTRICAL PRIME CONTRACTORS. THE LIST SHALL HAVE A DESCRIPTION OF THE ITEMS AND QUANTITY ALONG WITH A SIGN-OFF LINE FOR THE PLUMBING AND ELECTRICAL PRIME CONTRACTORS. A COPY OF THE SIGNED LIST IS TO BE SUBMITTED TO THE ARCHITECT / OWNER PRIOR TO BILLING FOR THIS


AND ELECTRICAL DEVICES, NIPPLES AND LOCKNUTS, ETC., FOR


- 8. EQUIPMENT SUB-CONTRACTOR SHALL MAKE SINK CUT-OUTS. 9. ALL OUTLETS WITHIN 6' OF A WATER SOURCE SHALL BE G.F.C.I. UNLESS
- NOTED OTHERWISE. 10. SINK CABINETS SHALL BE INSTALLED BEFORE THE INSTALLATION OF
- ADJACENT CABINETS. 11. ALL CONTRACTORS TO FIELD VERIFY ALL EXISTING CONDITIONS PRIOR TO CONSTRUCTION AND NOTIFY ARCHITECT IN WRITTEN FORM OF ANY
- DISCREPANCIES. 12. PROVIDE ALL FILLERS AS REQUIRED. FILLERS AT BASE CABINETS SHALL BE AT FRONT OF CABINET AND COUNTERTOP SHALL BE CONTINUOUS OVER FILLER PANEL. FILLERS AT TALL CABINETS SHALL BE AT FRONT AND TOP OF CABINET. FILLERS AT WALL CASES SHALL BE AT FRONT, TOP AND BOTTOM OF CABINET.
- FINISH TO MATCH CASEWORK. 13. ALL PRINTERS AND COMPUTERS ARE N.I.C. (TYPICAL)
- 14. RUBBER BASE ON ALL CASEWORK BY G.C. (TYPICAL) 15. ALL SCHEDULED EQUIPMENT MANUFACTURERS ARE "BASIS OF DESIGN", OR APPROVED EQUAL.

NOTE: ALL FURNITURE AND EQUIPMENT WITHOUT THE SYMBOL \langle OR MARKED (N.I.C.) IS NOT IN CONTRACT UNLESS NOTED OTHERWISE. SEE EQUIPMENT SCHEDULE FOR EQUIPMENT MARKED WITH THE SYMBOL /

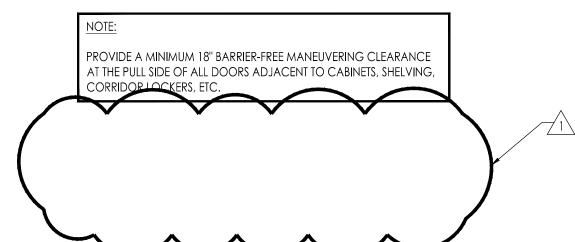



				EQUIPME	:NT SC	HEDUL	LE
TEM NO.	MANUFACTURER	CAT. NO.	DESCRIPTION	WIDT	H DEPTH	HEIGHT	REMARKS
1	CAMPBELL RHEA (OR APPROVED EQUAL)	5866	WARDROBE AND STORAGE CASE	35-1/4"	22-1/2"	84"	(1) FIXED SHELF; (3) ADJUSTABLE SHELVES; (1) HANGER ROD; 3 POINT LATCHING HANDLE. WARDROBE ON LEFT.
2	CAMPBELL RHEA (OR APPROVED EQUAL)	5690	TALL STORAGE CABINET	41-1/4"	22-1/2"	84"	(1) FIXED CENTER SHELF; (4) ADJUSTABLE SHELVES; ANCHOR TO WALL
3	CAMPBELL RHEA (OR APPROVED EQUAL)	3680C	OPEN BASE CABINET	35-1/4"	22-1/2"	33"	(2) ADJUSTABLE SHELVES
4	CAMPBELL RHEA (OR APPROVED EQUAL)	3755E	BASE CABINET	41-1/4"	22-1/2"	33"	DOUBLE DOORS; POWER/ DATA IN BASE CABINET; W/ BASE PANEL
5	CAMPBELL RHEA (OR APPROVED EQUAL)	3703E	BASE CABINET	41-1/4"	22-1/2"	33"	(4) DRAWERS AND DOOR HINGED LEFT; W/ BASE PANEL
6	CAMPBELL RHEA (OR APPROVED EQUAL)	6960	WARDROBE AND SUPPLY CASE	41-1/4"	22-1/2"	84"	(1) HANGER; (1) FIXED HAT SHELF; (2) ADJ. SHELVES; (2) LARGE FILE DRAWERS W/ FILE FOLLOWERS; (1) SHALLOW DRAWER W/ ADJ. PARTITIONS FOR RECORD CARDS UP TO 3"x5"; (1)10"x12" MIRROR; PIN TRA AND TOWEL BAR ON RIGHT HAND DOOR
7	CAMPBELL RHEA (OR APPROVED EQUAL)	7302	STUDENT WORK BENCH	54"	48"	31-1/4"	BASE CABINET HAS (12) INDIVIDUAL LOCKERS, MASTER KEYED. ASSEMBLY HAS (4) 7352-A WOODWORKI VISES WITH ALUMINUM HANDLES. TOP IS 2-1/4" LAMINATED HARD MAPLE.
8	CAMPBELL RHEA (OR APPROVED EQUAL)	3681D	BASE CABINET	35-1/4"	22-1/2"	33"	DOUBLE DOORS; (1) ADJ. SHELF
9	CAMPBELL RHEA (OR APPROVED EQUAL)	3681E	BASE CABINET	41-1/4"	22-1/2"	33"	DOUBLE DOORS; (1) ADJ. SHELF
10	CAMPBELL RHEA (OR APPROVED EQUAL)	3681C	BASE CABINET	30"	22-1/2"	33"	DOUBLE DOORS; (1) ADJ. SHELF
11	CAMPBELL RHEA (OR APPROVED EQUAL)	4710	WALL CABINET	47-1/4"	16"	23-3/4"	DOUBLE DOORS; (1) ADJ. SHELF
12	CAMPBELL RHEA (OR APPROVED EQUAL)	6779B	FLAMMABLE STORAGE CABINET	47"	22"	35"	36-GAL. CAPACITY METAL CAB. W/ (1) ADJ. SHELF; SWINGING DOORS OPEN TO 180°; DOORS HAVE THREE-POINT LATCHIN SYSTEM W/ BUILT-IN LOCK.
13	CAMPBELL RHEA (OR APPROVED EQUAL)	3681F	BASE CABINET	47-1/4"	22-1/2"	33"	DOUBLE DOORS; (1) ADJ. SHELF
14	CAMPBELL RHEA (OR APPROVED EQUAL)	4730	WALL CABINET	35-1/4"	16"	31-1/4"	DOUBLE DOORS; (2) ADJ. SHELF
15	CAMPBELL RHEA (OR APPROVED EQUAL)	8760	ADA CLOSURE PANEL ASSEMBLY	48"	22-1/2"	33"	
16	CAMPBELL RHEA (OR APPROVED EQUAL)	7075B	KNEESPACE COMPONENTS	35-1/4"	22-1/2"	4-7/8"	3/4" SOLID LUMBER FRONT RAIL W/ 30" CLEARANCE AREA
17	CAMPBELL RHEA (OR APPROVED EQUAL)	CDC36FB	BACK PANEL	36"	3/4"	30"	SOLID LUMBER TO MATCH REST OF CASEWORK
18	CAMPBELL RHEA (OR APPROVED EQUAL)	9084-152	FILLER	6"		84"	FIELD CUT
19	CAMPBELL RHEA (OR APPROVED EQUAL)	6784	SAFETY GOGGLES CABINET	24-1/2"	9-1/2"	32"	REINFORCED STEEL CABINET W/ BAKED WHITE ENAMEL FINISH & VANDAL RESISTANT LOCKING DOUBLE DOORS
20	CAMPBELL RHEA (OR APPROVED EQUAL)	6790	SAFETY GOGGLES				QUANTITY (36)
21	ICI SCIENTIFIC INC.	P967-24	FUME HOOD BASE CABINETS	24"	22"	32"	(1) ADJUSTABLE SHELF; FULL SOLID BACK FOR ADDED SUPPORT
22	BMC LABORATORY	B-810	SPRAY BOOTH	24"	22"	46-1/2"	SEE SPECIFICATION FOR ACCESSORIES I.E. EXHAUST BLOWER; EXPLOSION PROOF LIGHT FIXTURE; EXPLOS PROOF RECEPTACLE; EXPLOSION PROOF SWITCH; EPOXY RESIN COUNTERTOP; FLAME RETARDANT CURW/TRACK
23	ELKAY	LRADQ252260	LUSTERTONE CLASSIC STAINLESS STEEL	25"	22"	6"	SOUND DEADEN AT BOTTOM
24	JUST	J-1174-KS	FAUCET GROUP	8"		12-1/8"	4" VANDAL RESISTANT WRIST BLADES; 1.0 GPM AERATORS; ADA COMPLIANT
25	WATER SAVER	EW806	EYEWASH, DECK MOUNTED				RIGHT HAND MOUNTED; DUST COVER FOR EACH SPRAY HEAD; AP3600 THERMOSTATIC MIXING VALVE
26	VIRCO (OR APPROVED EQUAL)	1211927FG	LAB STOOLS - 121 SERIES	17-7/8"	17-7/8"	VARIES	ADJ. HEIGHT STOOL- HARD PLASTIC SEAT W/ FELT-BASE GLIDES
27	VIRCO (OR APPROVED EQUAL)	FTT2460	FLIP-TOP TECHNOLOGY TABLES	60"	24"	34"	ADJ. HEIGHT;18" DEEP WORK SURFACE W/ 6" DEEP FLIP-TOP COMPARTMENT FOR WIRE MANAGMENT
28	VIRCO (OR APPROVED EQUAL)	ZU418-FG-BR	ZUMBA® SERIES - STUDENT CHAIRS	20-3/4"	20-5/8"	32-1/4"	18" SEAT-HEIGHT; PROVIDE W/ FELT-BASE GLIDES AND BOOKRACK
29	VIRCO (OR APPROVED EQUAL)	4301	TASK CHAIR - 4300 SERIES	19-3/4"	18-1/2"	VARIES	ADJ. SEAT HEIGHT
30	VIRCO (OR APPROVED EQUAL)	IMT2	INSTRUCTOR MEDIA TOWER	27"	30"	40-5/8"	PROVIDE W/ LECTERN TOP (IMTIT); AND CASTERS
31	VIRCO (OR APPROVED EQUAL)	T762ELECT	POWER STRIP - PLATEAU® SERIES				12' CORD POWER STRIP W/ DIAGNOSTIC LEDs W/ 7 OUTLETS & EXCEEDS IEEE 587 CATEGORY A&B SURG SUPPRESSION SPECIFICATIONS. PROVIDE (1) FOR EACH DESK; TOTAL OF (12)

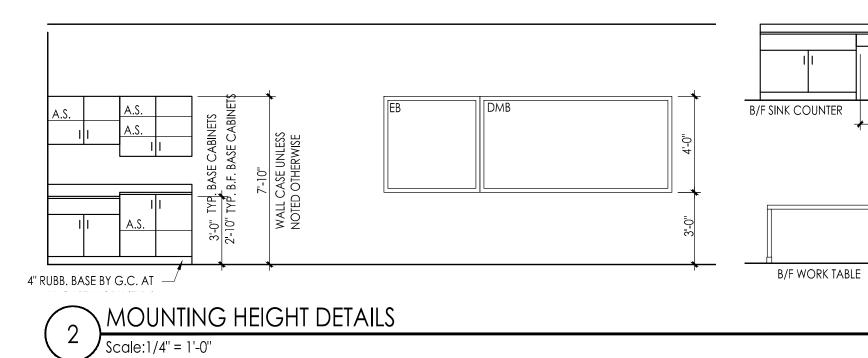


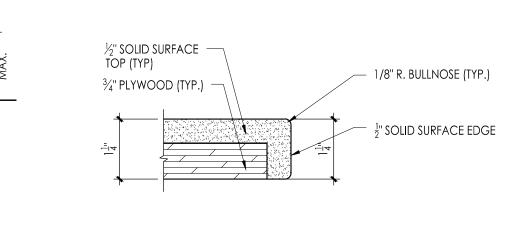

SOLID SURFACE EDGE DETAIL Scale:6" = 1'-0"

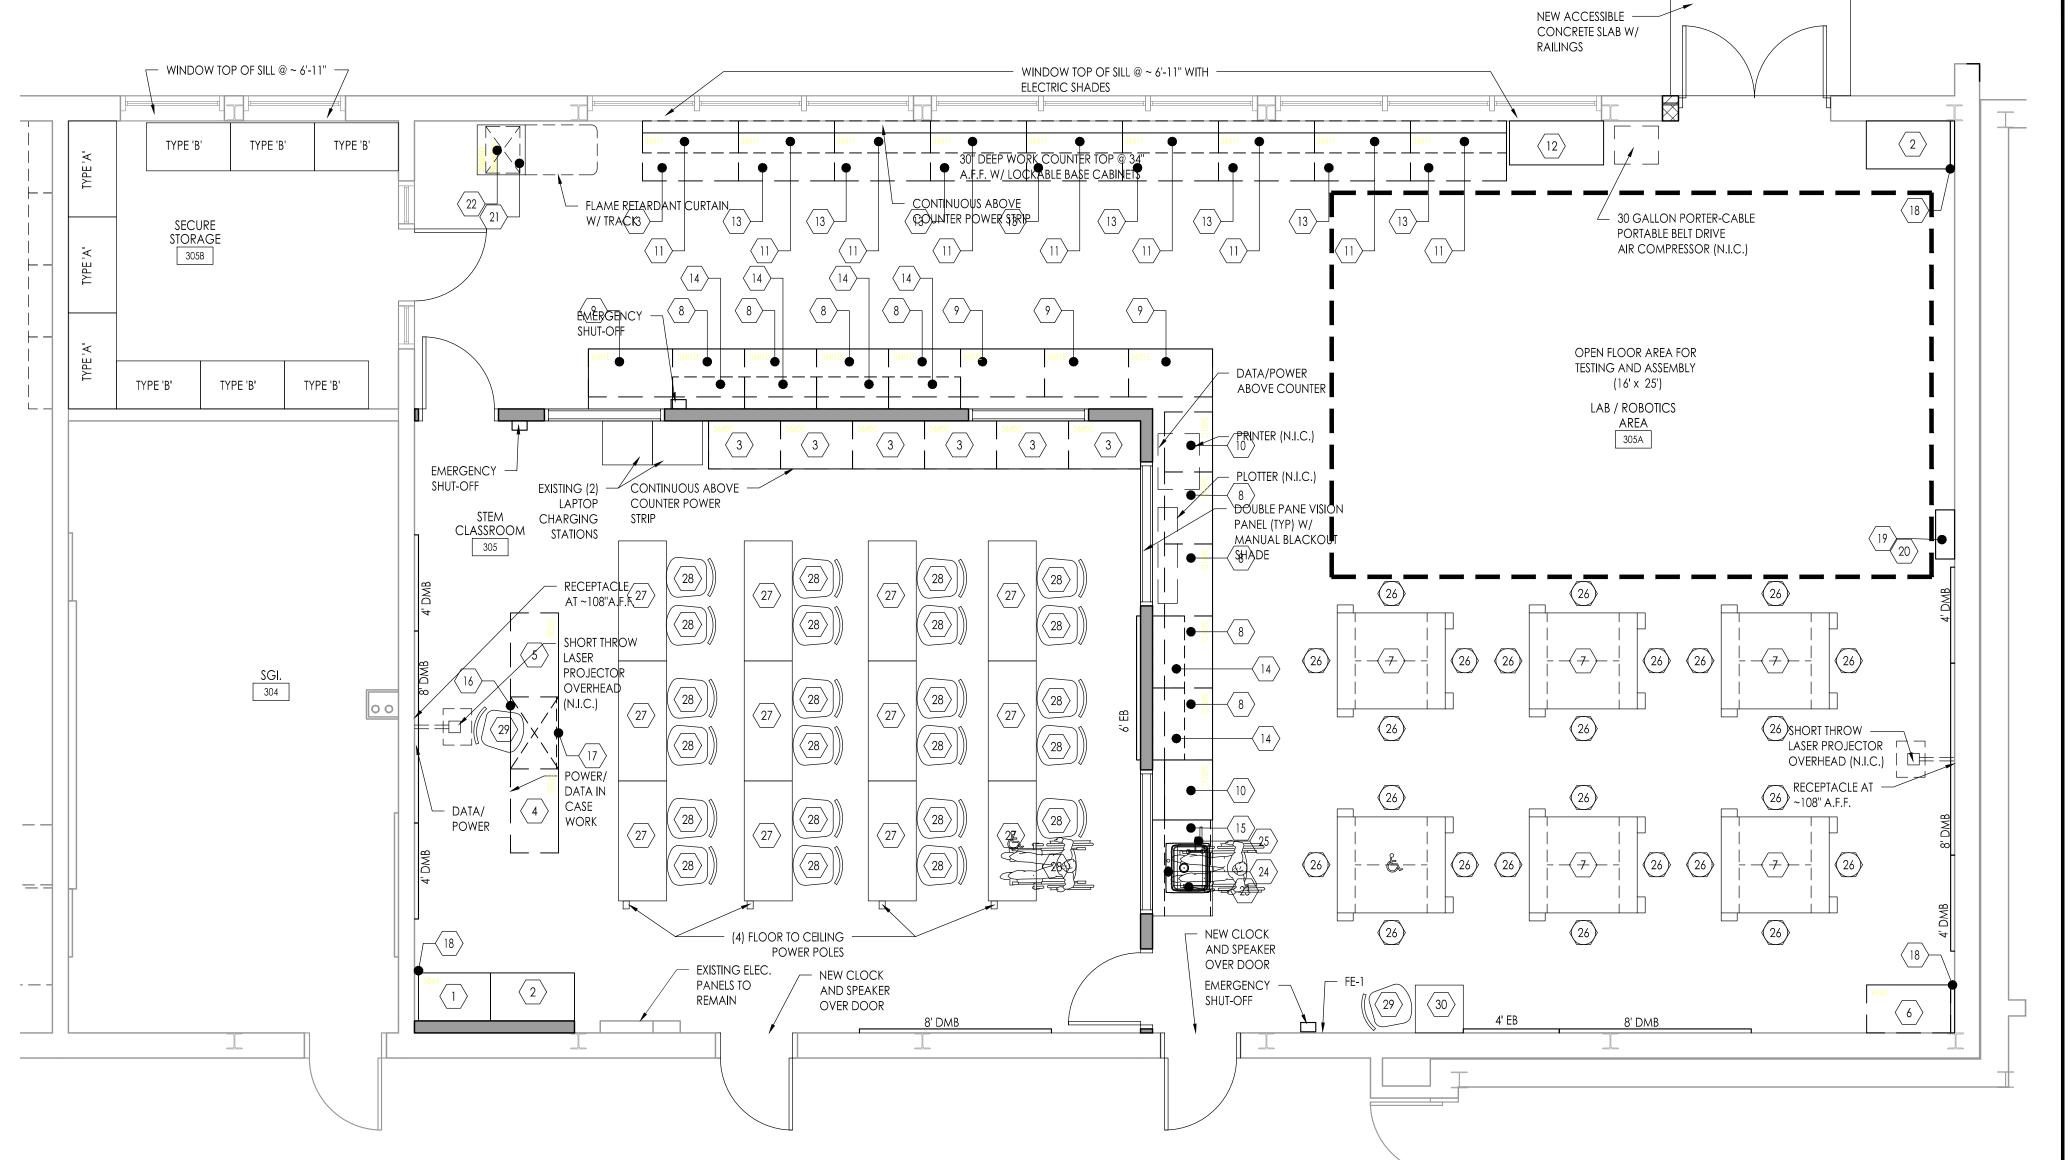


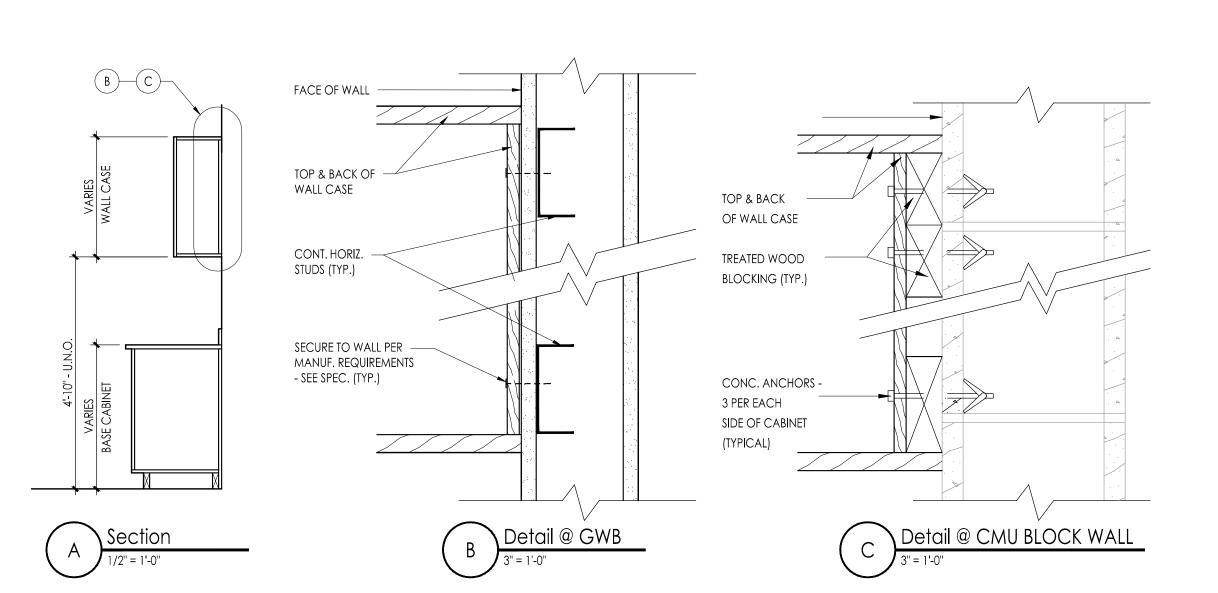

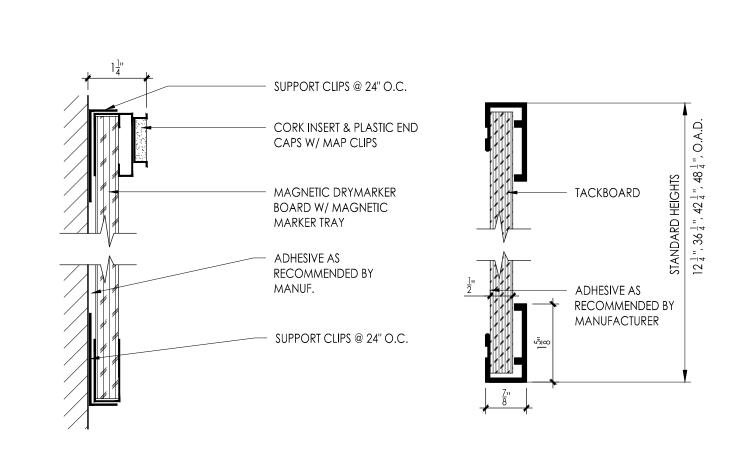

MARKER/EXIBITION BOARD DETAILS

CABINET WALL MOUNT DETAILS

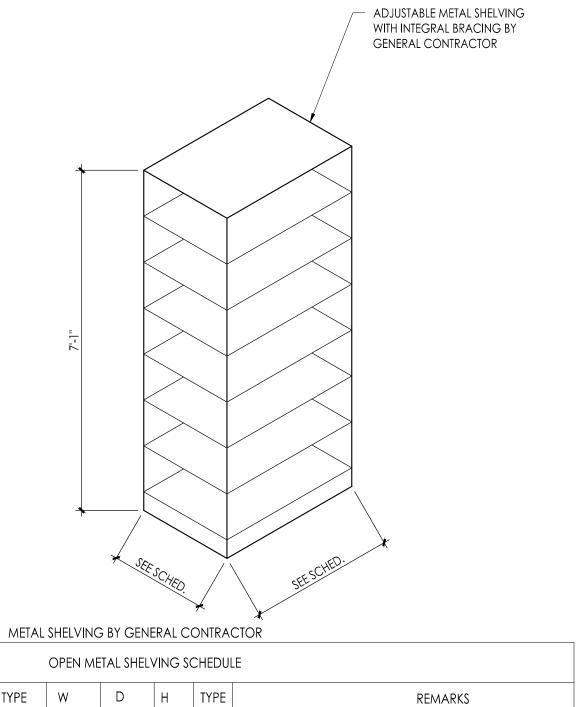

OPEN METAL SHELVING SCHEDULE									
TYPE	W	D	Н	TYPE	REMARKS				
Α	48"	24"	7'-1"	Α	4 ADJ SHELVES 1 FIXED (SPACED AT 18")				
В	42"	24"	<i>7</i> '-1''	Α	4 ADJ SHELVES 1 FIXED (SPACED AT 18")				

METAL SHELVING TYPES

ENLARGED ROOM LAYOUT

1/4" = 1'-0"

Scale:VARIES

STEM Lab Alterations & Renovations at Clearview Regional Middle School

Project Owner Name Clearview Regional High School District


Project Location 595 Jefferson Rd, Mullica Hill, NJ 08062

Project Number 5162C Project Date 10/11/2023 Checked By GRD Drawn By KM/SB Scale

AS NOTED Drawing Name

ENLARGED ROOM LAYOUT

No. Date Description 10.20.23 ADDENDUM 1

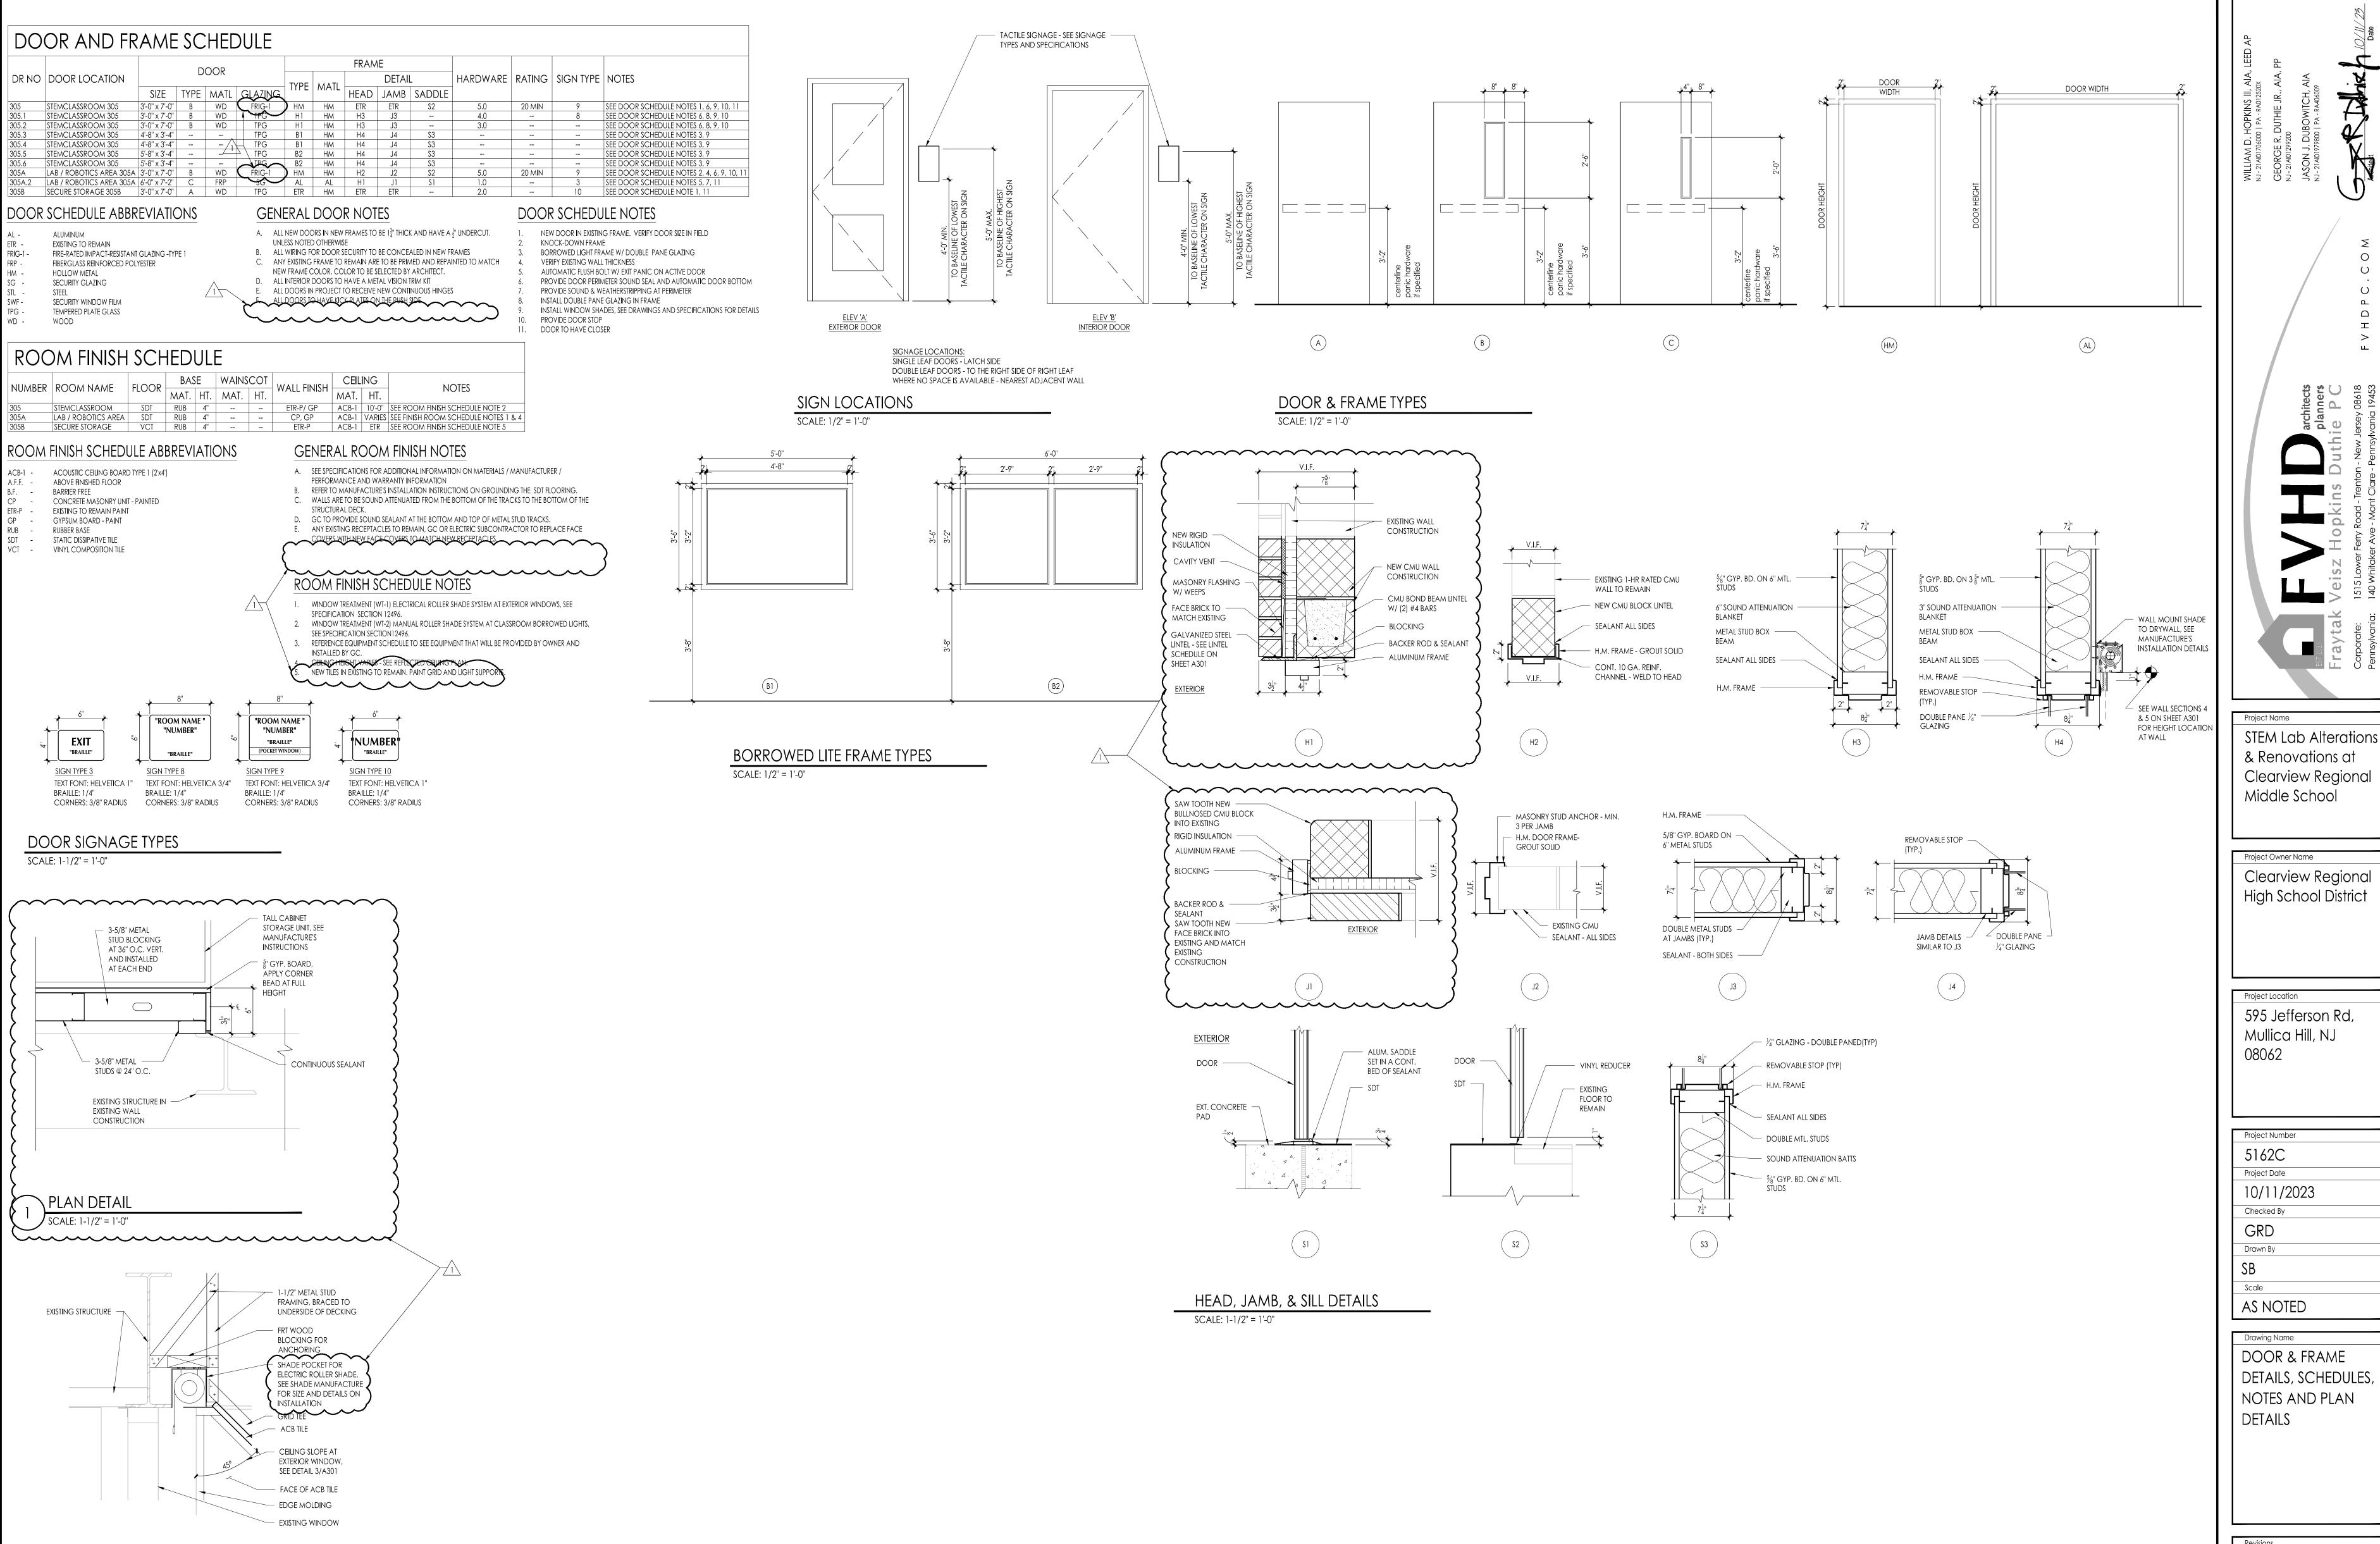

SELECTRIC ROLLER SHADE POCKET AT WINDOW

Project Owner Name Clearview Regional High School District

Project Location 595 Jefferson Rd, Mullica Hill, NJ

Project Number 5162C Project Date 10/11/2023

Checked By Drawn By

AS NOTED

DOOR & FRAME DETAILS, SCHEDULES, NOTES AND PLAN DETAILS

No. Date Description 10.20.23 ADDENDUM 1

FLOOR PATTERN LAYOUT

Scale: 1/4" = 1'-0"

STATIC DISSIPATIVE TILE LEGEND (STD)

SDT1: 24"x24" Tarkett - iQ Granit SD

SDT2: 24"x24" Tarkett - iQ Granit SD

SDT3: 24"x24" Tarkett - iQ Granit SD

VINYL COMPOSITION TILE (VCT)

VCT1: 12"x12" Tarkett -VCT ||

Clearview Regional Middle School

& Renovations at

Project Owner Name Clearview Regional High School District

STEM Lab Alterations

Project Location 595 Jefferson Rd, Mullica Hill, NJ 08062

Project Number

5162C Project Date

10/11/2023 Checked By

GRD Drawn By

1/4"=1'-0"

Drawing Name

FLOOR PATTERN LAYOUTS

No. Date Description 10.20.23 ADDENDUM 1